PROJECT LOCATION

NOTES:

ANY MATERIAL.


# COUNTY OF SANTA CLARA ROADS AND AIRPORTS DEPARTMENT

PLANS FOR THE CONSTRUCTION OF

# UVAS CREEK BRIDGE NO. 37C0094 REPLACEMENT AT UVAS ROAD

NEW BRIDGE NO. 37C0600 (EXISTING BRIDGE NO. 37C0094) FEDERAL PROJECT NUMBER BRLS-5937(123) LOCATED 4 MILES SOUTHWEST OF THE CITY OF MORGAN HILL

> TO BE SUPPLEMENTED BY COUNTY STANDARD PLANS DATED SEPTEMBER 1997 COUNTY STANDARD SPECIFICATIONS DATED MAY 2000 STATE OF CALIFORNIA STANDARD PLANS AND SPECIFICATIONS DATED 2018

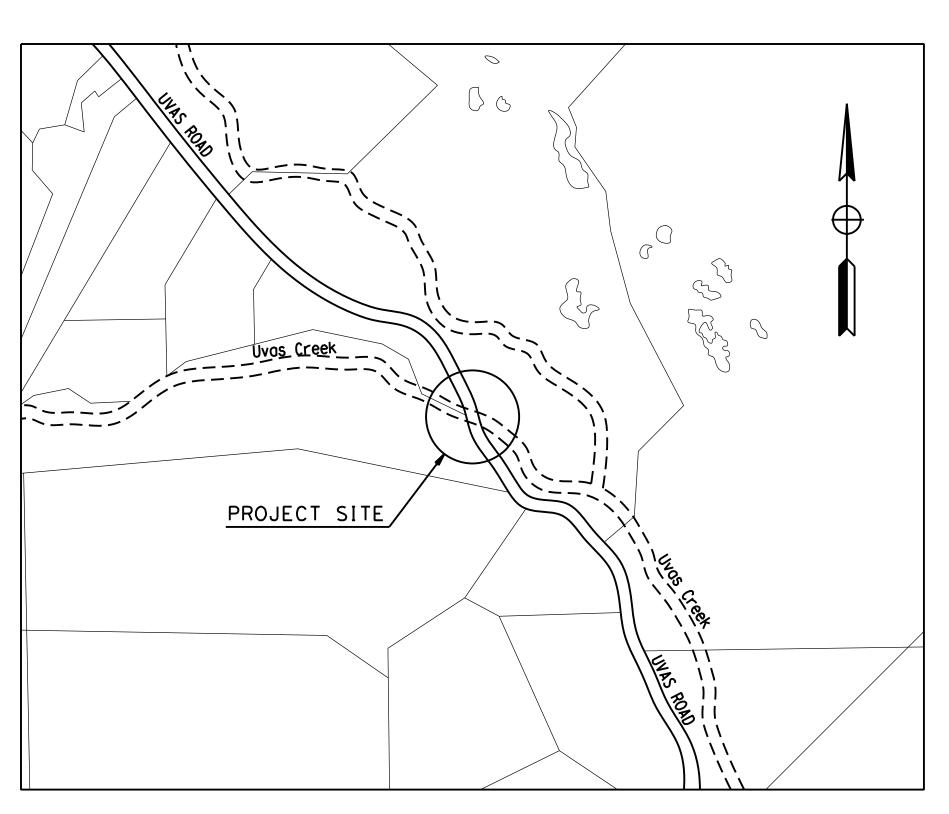

SITE MAP NO SCALE

### INDEX OF PLANS

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### STRUCTURE PLANS

PROJECT NO. C4328

27 28	GENERAL PLAN DECK CONTOURS
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35	TYPICAL SECTION
36	GIRDER LAYOUT
37	GIRDER REINFORCEMENT
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39	LOG OF TEST BORINGS

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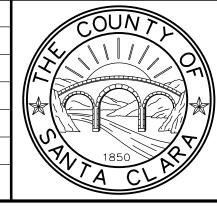
THE CONTRACTOR SHALL VERIFY ALL CONTROLLING

FIELD DIMENSIONS BEFORE ORDERING OR FABRICATING

SOUTH COUNTY

SANTA CLARA COUNTY

NTS



COUNTY	OF	SANTA	CLARA	ROADS	AND	AIRPORTS	DEPARTMENT
. Panayotov	9/202	20	APPROVED: HARRY FREITAS DIRECTOR				
ESIGNED	DA	ATE WORK ORDER					
. Panayotov	9/202	20		gned by:			
RAWN	D.	ATE LEVEL BOOK	-    Harry	Freitas			
OLOMON TEGEGNE	9/202	20	6DC289	84CB2D46D			

UVAS CREEK BRIDGE NO. 37C0094 REPLACEMENT AT UVAS ROAD

CONTRACT No.

TITLE SHEET

DRAWING No.

POST MILES SHEET TOTAL TOTAL PROJECT NO. SHEETS

11017 COBBLEROCK DRIVE, SUITE 100

RANCHO CORDOVA, CA 95670 P: 916.368.9181

REGISTERED CIVIL ENGINEER DATE

December 20, 2022

THE COUNTY OR ITS OFFICERS OR AGENTS SHALL NOT BE RESPONSIBLE FOR THE ACCURACY OR COMPLETENESS OF SCANNED COPIES OF THIS PLAN SHEET.

PLANS APPROVAL DATE

ENGINEERING

### STANDARD GENERAL NOTES


- THE CONTRACTOR AGREES THAT, IN ACCORDANCE WITH GENERALLY ACCEPTED CONSTRUCTION PRACTICES, THE CONTRACTOR WILL BE REQUIRED TO ASSUME SOLE AND COMPLETE RESPONSIBILITY FOR JOB SITE CONDITIONS DURING THE COURSE OF CONSTRUCTION OF THE PROJECT, INCLUDING SAFETY OF ALL PERSONS AND PROPERTY. THIS REQUIREMENT SHALL BE MADE TO APPLY CONTINUOUSLY AND NOT BE LIMITED TO NORMAL WORKING HOURS. THE CONTRACTOR FURTHER AGREES TO DEFEND, INDEMNIFY AND HOLD COUNTY AND ENGINEER HARMLESS FROM ANY AND ALL LIABILITY, REAL OR ALLEGED, IN CONNECTION WITH THE PERFORMANCE OF WORK ON THIS PROJECT.
- 2. IT IS THE RESPONSIBILITY OF THE CONTRACTOR TO OBTAIN PERMITS NECESSARY TO PERFORM WORK BEYOND THE LIMITS SHOWN ON THESE PLANS SUCH AS ADDITIONAL STAGING AREAS OR TEMPORARY FACILITIES. ANY COST RELATED TO OBTAINING ADDITIONAL STAGING AREA OR TEMPORARY FACILITIES SHALL BE THE SOLE RESPONSIBILITY OF THE CONTRACTOR.
- 3. THE CONTRACTOR SHALL PROVIDE FOR INGRESS AND EGRESS FOR PRIVATE PROPERTY ADJACENT TO WORK THROUGHOUT THE PERIOD OF CONSTRUCTION. THIS WORK SHALL BE CONSIDERED INCIDENTAL TO TRAFFIC CONTROL SYSTEM PAY ITEM.
- 4. THE CONTRACTOR SHALL POST EMERGENCY TELEPHONE NUMBERS FOR POLICE, FIRE, AMBULANCE, AND THOSE AGENCIES RESPONSIBLE FOR MAINTENANCE OF UTILITIES IN THE VICINITY OF JOB SITE.
- 5. ANY EXTRA CONSTRUCTION STAKING NECESSITATED SOLELY BY THE CONTRACTOR'S NEGLIGENCE WILL BE CHARGED TO THE CONTRACTOR ON A TIME AND EXPENSES BASIS AND PAID FOR BY THE CONTRACTOR.
- 6. STATIONING HEREON IS ALONG ROADWAY CENTERLINE UNLESS OTHERWISE SHOWN OR INDICATED.
- 7. ALL RETURN RADII AND CURB DATA ARE TO EDGE OF PAVEMENT.
- 8. ALL QUANTITIES AND PAY ITEMS ARE AND WILL BE BASED ON HORIZONTAL MEASUREMENTS. IF APPLICABLE.
- 9. LENGTHS OF STORM DRAINS ARE HORIZONTAL DISTANCES FROM CENTER TO CENTER OF STRUCTURES.
- 10. EXISTING UNDERGROUND UTILITIES AND IMPROVEMENTS ARE SHOWN IN THEIR APPROXIMATE LOCATIONS BASED UPON RECORD INFORMATION AVAILABLE TO THE ENGINEER AT THE TIME OF PREPARATION OF THESE PLANS. LOCATIONS MAY NOT HAVE BEEN VERIFIED IN THE FIELD AND NO GUARANTEE IS MADE AS TO THE ACCURACY OR COMPLETENESS OF THE INFORMATION SHOWN. IF THE CONTRACTOR DEEMED NECESSARY TO RELOCATE EXISTING UTILITY LINE DURING CONSTRUCTION THEY SHALL NOTIFY UTILITY COMPANIES AT LEAST ONE WEEK IN ADVANCE OF CONSTRUCTION TO FIELD LOCATE UTILITIES. CALL UNDERGROUND SERVICE ALERT (U.S.A.), AT 811–227–2600. IT SHALL BE THE RESPONSIBILITY OF THE CONTRACTOR TO DETERMINE THE EXISTENCE AND LOCATION OF THOSE UTILITIES SHOWN ON THESE PLANS OR INDICATED IN THE FIELD BY LOCATING SERVICES. ADDITIONAL COSTS INCURRED AS A RESULT OF CONTRACTOR'S FAILURE TO VERIFY LOCATIONS OF EXISTING UTILITIES PRIOR TO BEGINNING OF CONSTRUCTION IN THEIR VICINITY SHALL BE BORNE BY THE CONTRACTOR AND ASSUMED INCLUDED AND MERGED IN THE CONTRACT UNIT PRICE.
- 11. ALL EXISTING UTILITIES AND IMPROVEMENTS THAT BECOME DAMAGED DURING CONSTRUCTION SHALL BE COMPLETELY RESTORED TO THE SATISFACTION OF THE LOCAL AGENCY ENGINEER, AT THE CONTRACTOR'S SOLE EXPENSE. THE CONSTRUCTION OF ALL GRAVITY UNDERGROUND LINES (STORM DRAINS) SHALL BEGIN AT THE MOST DOWNSTREAM END, UNLESS OTHERWISE SPECIFICALLY APPROVED BY THE LOCAL AGENCY ENGINEERS.
- 12. ANY RELOCATION OF PUBLIC UTILITIES SHALL BE CONDUCTED IN ACCORDANCE WITH ANY AND ALL REQUIREMENTS OF THE UTILITY COMPANY INCLUDING FEES, BONDS, PERMITS AND WORKING CONDITIONS, ETC. THIS WORK SHALL BE DONE AT THE UTILITY COMPANY EXPENSE.
- 13. IF ARCHEOLOGICAL MATERIALS ARE UNCOVERED DURING GRADING, TRENCHING OR OTHER EXCAVATION, EARTHWORK WITHIN 100 FEET OF THESE MATERIALS SHALL BE STOPPED UNTIL A PROFESSIONAL ARCHAEOLOGIST WHO IS CERTIFIED BY THE SOCIETY OF CALIFORNIA ARCHAEOLOGY (SCA) AND/OR THE SOCIETY OF PROFESSIONAL ARCHAEOLOGY (SOPA) HAS HAD AN OPPORTUNITY TO EVALUATE THE SIGNIFICANCE OF THE FIND AND SUGGEST APPROPRIATE MITIGATION MEASURES, IF THEY ARE DEEMED NECESSARY.
- 14. DESIGN ENGINEER DOES NOT SPECIFY OR RECOMMEND THE USE OR INSTALLATION OF ANY MATERIAL OR EQUIPMENT WHICH IS MADE FROM, OR WHICH CONTAINS ASBESTOS FOR USE IN THE CONSTRUCTION OF THESE IMPROVEMENTS. ANY PARTY INSTALLING OR USING SUCH MATERIALS OR EQUIPMENT SHALL BE SOLELY RESPONSIBLE FOR ALL INJURIES, DAMAGES, OR LIABILITIES OF ANY KIND, CAUSED BY THE USE OF SUCH MATERIALS OR EQUIPMENT. THE PROVISIONS OF THIS NOTE SHALL APPLY UNLESS THEY ARE EXPRESSLY WAIVED IN WRITING BY DESIGN ENGINEER.
- 15. THE CONTRACTOR SHALL MEET AND FOLLOW ALL NPDES REQUIREMENTS IN EFFECT AT THE TIME OF CONSTRUCTION.
- 16. SHOULD IT APPEAR THAT THE WORK TO BE DONE OR ANY MATTER RELATIVE THERETO IS NOT SUFFICIENTLY DETAILED OR EXPLAINED ON THESE PLANS, THE CONTRACTOR SHALL NOTIFY THE ENGINEER FOR SUCH FURTHER EXPLANATIONS AS MAY BE NECESSARY.

**PROJECT NOTES** 

- THE CONTRACTOR SHALL NOT DESTROY ANY PERMANENT SURVEY POINTS WITHOUT THE CONSENT OF THE COUNTY ENGINEER. ANY PERMANENT MONUMENTS OR POINTS DESTROYED SHALL BE REPLACED BY A LICENSED LAND SURVEYOR AT THE CONTRACTOR'S EXPENSE.
- 2. THE CONTRACTOR IS RESPONSIBLE FOR MATCHING EXISTING STREETS, SURROUNDING LANDSCAPE AND OTHER IMPROVEMENTS WITH A SMOOTH TRANSITION IN PAVING, CURBS, GUTTERS, SIDEWALKS, GRADING, ETC. AND TO AVOID ANY ABRUPT OR APPARENT CHANGES IN GRADES OR CROSS SLOPES, LOW SPOTS OR HAZARDOUS CONDITIONS.
- 3. THESE PLANS AND SPECIFICATIONS, INCLUDING GRADES AND STREET DRAINAGE ARE SUBJECT TO MODIFICATION DURING CONSTRUCTION SHOULD CONDITIONS APPEAR THAT WERE NOT APPARENT DURING DESIGN. ANY SUCH MODIFICATION SHALL BE APPROVED BY COUNTY ENGINEER.
- 4. THE CONTRACTOR SHALL BE HELD RESPONSIBLE FOR ANY FIELD CHANGES MADE WITHOUT WRITTEN AUTHORIZATION FROM THE COUNTY ENGINEER.
- 5. A COUNTY GEOTECHNICAL ENGINEER SHALL BE ON SITE DURING GRADING AND INSTALLATION OF WALLS, BRIDGE FOUNDATIONS, ETC. CONTRACTOR SHALL NOTIFY THE COUNTY A MINIMUM OF 48 HOURS IN ADVANCE BEFORE STARTING THESE ACTIVITIES.
- 6. IT SHALL BE THE CONTRACTOR'S RESPONSIBILITY TO IMMEDIATELY NOTIFY THE COUNTY, THE OWNER AND THE DESIGN ENGINEER UPON DISCOVERY OF ANY FIELD CONFLICTS.
- 7. ANY DEVIATIONS OR CHANGES IN THESE PLANS WITHOUT OFFICIAL APPROVAL OF THE DESIGN ENGINEER SHALL ABSOLVE THE DESIGN ENGINEER OF ANY AND ALL RESPONSIBILITY OF SAID DEVIATION OR CHANGE.
- 8. IT IS THE CONTRACTOR'S RESPONSIBILITY TO ENSURE THAT ALL MANHOLES ARE SET TO FINISHED PAVEMENT GRADE.

### **NOTES**

- 1. ALL ROAD IMPROVEMENTS SHALL BE CONSTRUCTED IN ACCORDANCE WITH THE CURRENT VERSION OF THE STATE AND COUNTY STANDARD SPECIFICATIONS, AND STANDARD PLANS. ALL PEDESTRIAN IMPROVEMENTS SHALL CONFORM WITH THE REQUIREMENTS OF TITLE 24 OF THE CALIFORNIA CODE OF REGULATIONS AND THE AMERICAN WITH DISABILITIES ACT. THE IMPROVEMENTS ARE SUBJECT TO THE INSPECTION AND APPROVAL OF THE COUNTY.
- 2. ALL REVISIONS TO THIS PLAN MUST BE REVIEWED BY THE COUNTY ROAD AND AIRPORT DEPARTMENT PRIOR TO CONSTRUCTION AND SHALL BE ACCURATELY SHOWN ON REVISED PLANS STAMPED AND DISTRIBUTED BY THE ENGINEERING SERVICES DIVISION PRIOR TO ACCEPTANCE OF THE WORK AS COMPLETE.
- PRIOR TO PLACING CURB, SIDEWALK, ASPHALT CONCRETE, SUBBASE, OR BASE MATERIAL, ALL UNDERGROUND UTILITIES WITHIN THE RIGHT OF WAY SHALL BE INSTALLED, BACKFILL COMPLETED, AND THE COUNTY ROAD AND AIRPORT DEPARTMENT'S CONSTRUCTION DIVISION NOTIFIED, BY EACH OF THE UTILITY COMPANIES HAVING FACILITIES WITHIN THE WORK AREA, THAT THE UTILITY INSTALLATION HAS SATISFACTORILY PASSED ACCEPTANCE TESTS.
- 4. WHEN WIDENING THE PAVEMENT ON AN EXISTING ROAD, THE EXISTING PAVEMENT SHALL BE CUT TO A NEAT LINE AND REMOVED TO AN EXISTING ADEQUATE STRUCTURAL SECTION. AN EXPLORATORY TRENCH OR POTHOLING, MAY BE REQUIRED TO DETERMINE THE LIMITS OF PAVEMENT REMOVAL.
- 5. NO TREES SHALL BE REMOVED UNLESS THEY ARE SHOWN AND NOTED TO BE REMOVED ON THE IMPROVEMENT PLANS. IF ANY TREES ARE TO BE REMOVED, THE IMPROVEMENT PLANS MUST BE REVIEWED AND ACKNOWLEDGED BY THE COUNTY. ALL TREES CONFLICTING WITH GRADING, UTILITIES, OR OTHER IMPROVEMENTS, OR OVERHANGING THE PAVEMENT SO AS TO FORM A NUISANCE OR HAZARD, SHALL BE TRIMMED, PROPERLY TREATED AND SEALED. A TREE PERMIT MAY BE NECESSARY.
- 6. THE CONTRACTOR SHALL COMPLY WITH ALL RULES, REGULATIONS AND PROCEDURES OF THE NATIONAL POLLUTANT DISCHARGE ELIMINATION SYSTEM (NPDES) FOR MUNICIPAL, CONSTRUCTION AND INDUSTRIAL ACTIVITIES AS PROMULGATED BY THE CALIFORNIA STATE WATER RESOURCE CONTROL BOARD OR ANY OF ITS REGIONAL WATER QUALITY CONTROL BOARDS.
- 7. THE CONTRACTOR IS RESPONSIBLE FOR PRESERVATION AND/OR PERPETUATION OF ALL EXISTING MONUMENTS (THAT CONTROL SUBDIVISIONS, TRACTS, STREETS OR HIGHWAYS, OR PROVIDE SURVEY CONTROL) WHICH WILL BE DISTURBED OR REMOVED DUE TO CONTRACTORS' WORK. THE CONTRACTOR SHALL PROVIDE A MINIMUM OF 10 WORKING DAYS NOTICE, TO COUNTY, PRIOR TO DISTURBANCE OR REMOVAL OF EXISTING MONUMENTS. COUNTY SHALL COORDINATE WITH THE CONTRACTOR TO RESET MONUMENTS OR PROVIDE PERMANENT WITNESS MONUMENTS AND FILE THE REQUIRED DOCUMENTATION WITH THE COUNTY SURVEYOR, PER BUSINESS AND PROFESSIONAL CODE SECTION 8771.
- 8. ANY MATERIAL IMPORTED FOR THE CONSTRUCTION OF EMBANKMENT OR AS BACKFILL FOR STRUCTURES, CULVERTS AND OTHER FACILITIES SHALL MEET THE GEOTECHNICAL REQUIREMENTS.
- 9. STORM WATER INLETS AND MANHOLES INVERTS SHALL BE SHAPED AND SLOPED TO DRAIN.
- 10. DEMOLITION OF EXISTING BRIDGE WILL INVOLVE CONSTRUCTION OF A TEMPORARY DECKING OR OTHER SYSTEM OVER THE CREEK CHANNEL TO AVOID DROPPING INTO THE CREEK. THE COST FOR THIS WORK SHALL BE CONSIDERED INCIDENTAL TO BRIDGE REMOVAL PAY ITEM.

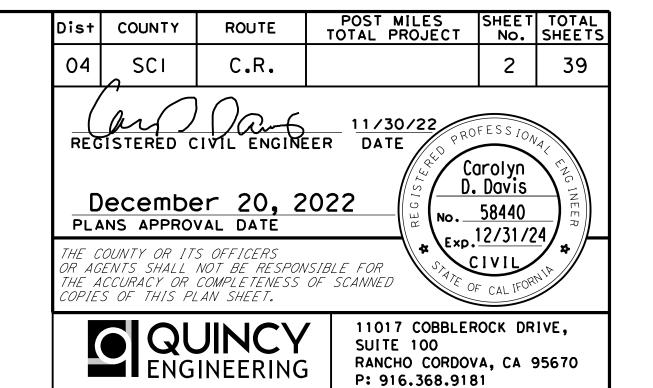


### SANTA CLARA HABITAT PLAN (SCVHP) NOTES

- 1. THE CONTRACTOR SHALL BE AWARE THAT THIS PROPOSED PROJECT IS A COVERED PROJECT UNDER THE SCVHP AND WILL IMPLEMENT THE FOLLOWING CONDITIONS FROM THE SCVHP:
- A. CONDITION 1. AVOID DIRECT IMPACTS ON LEGALLY PROTECTED PLANT AND WILDLIFE SPECIES
- B. CONDITION 3. MAINTAIN HYDROLOGIC CONDITIONS AND PROTECT WATER QUALITY
- C. CONDITION 4. STREAM AVOIDANCE AND MINIMIZATION FOR IN-STREAM PROJECTS.
- D. CONDITION 6. DESIGN AND CONSTRUCTION REQUIREMENTS FOR COVERED TRANSPORTATION PROJECTS
- E. CONDITION 7. RURAL DEVELOPMENT DESIGN AND CONSTRUCTION REQUIREMENTS. F. CONDITION 12. WETLAND AND POND AVOIDANCE AND MINIMIZATION
- G. CONDITION 14. VALLEY OAK AND BLUE OAK WOODLAND AVOIDANCE AND MINIMIZATION

DIRECTLY, BUT SHALL BE CONSIDERED INCIDENTAL TO ALL PROJECT CONTRACT ITEMS.

- H. CONDITION 20. AVOID AND MINIMIZE IMPACTS TO COVERED PLANT OCCURRENCES.

  2. THE COST FOR IMPLEMENTING THE ABOVE SCVHP CONDITIONS WILL NOT BE PAID FOR
- 3. THE CONTRACTORS ATTENTION IS DIRECTED TO ALL PERMITS AND SANTA CLARA VALLEY HABITAT AGENCY WEBSITE REGARDING SCVHP REQUIREMENTS. HTTP://SCV-HABITATAGENCY.ORG/

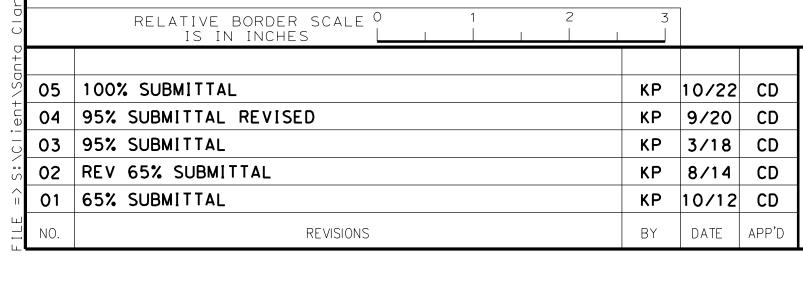



# COUNTY OF SANTA CLARA ROADS AND AIRPORTS DEPARTMENT

K. Panayotov 9/2020

DESIGNED DATE

R. Rameriz 9/2020

DRAWN DATE

B. Grimm 9/2020

BARNI RONCAL ASSISTANT CIVIL ENGINEER POCUSigned by:

ROCELIA KMAK
PRINCIPAL CIVIL ENGINEER

SOLOMON TEGEGNE
SOLOMON TEGEGNE
SENIOR CIVIL ENGINEER

SOLOMON TEGEGNE
SENIOR CIVIL ENGINEER

SOLOMON TEGEGNE
SENIOR CIVIL ENGINEER

UVAS CREEK BRIDGE NO. 37C0094 REPLACEMENT AT UVAS ROAD

GENERAL NOTES

SHT No. **2** OF **39** 

N-1


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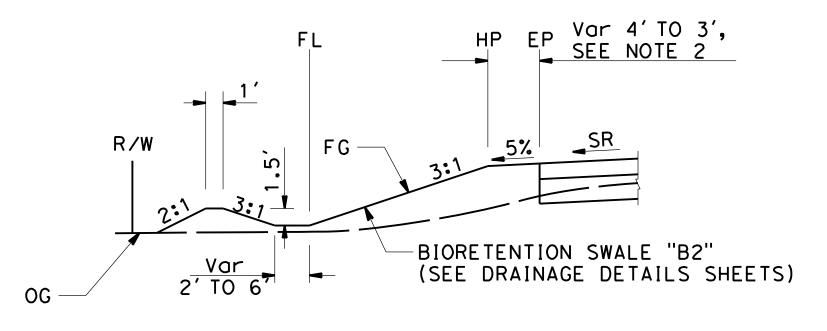
PCA C4328 ADVERTISEMENT DATE: CONTRACT No. FILE No. Scale AS SHOWN

### POST MILES SHEET TOTAL TOTAL PROJECT NO. SHEETS Dist| COUNTY NOTES: DESIGN DESIGNATION ABBREVIATIONS: 04 SCI C.R. 1. DIMENSIONS OF THE PAVEMENT STRUCTURES (STRUCTURAL SECTIONS) ARE 2007 ADT = 2,090SUBJECT TO TOLERANCES SPECIFIED IN THE STANDARD SPECIFICATIONS. SUPERELEVATION RATE 2028 ADT = 2,600V = 45 MPH REGISTERED CIVIL ENGINEER DATE 11/30/22 2. SUPERELEVATIONS ARE SHOWN ON THE SUPERELEVATION DIAGRAMS. TI = 8.5Carolyn D. Davis R = 403. FOR FL ELEVATIONS, SEE DRAINAGE DETAILS SHEETS. December 20, 2022 No. 58440 PLANS APPROVAL DATE $\sqrt{\text{Exp.}}\frac{12/31/24}{}$ 4. SLOPE VARIES FROM 2:1 TO 20:1 FROM STATION "A" 22+00.00 TO "A" 22+45.00. THE COUNTY OR ITS OFFICERS OR AGENTS SHALL NOT BE RESPONSIBLE FOR THE ACCURACY OR COMPLETENESS OF SCANNED COPIES OF THIS PLAN SHEET. 5. SLOPE 1:1 FROM "A" 23+75.00 TO "A" 23+95.00. 11017 COBBLEROCK DRIVE, SUITE 100 QUINCY 6. UNPAVED SHOULDER WIDTH PER TYPICAL MGS LAYOUT AT STRUCTURE APPROACH AND DEPARTURE. SEE STANDARD PLANS A77Q2 AND RSP A77Q4. RANCHO CORDOVA, CA 95670 P: 916.368.9181 ENGINEERING 7. FOR DIKE LOCATION AND TYPE, SEE LAYOUT SHEET. -3'SIDE DITCH "D1" GUTTER Var 1' TO 4', EP Var SEE NOTE 6 R/W -2:1 (SEE NOTE 4) -HMA DIKE (TYPE A) 2:1 SEE NOTE 5 Var -BIORETENTION SWALE "B1" -HMA DIKE (SEE DRAINAGE DETAILS SHEETS) Sta "A" 20+64.80 TO Sta "A" 20+83.82 Sta "A" 23+55.00 TO Sta "A" 24+73.11 Sta "A" 21+33.26 TO Sta "A" 22+45.00 "A" LINE R/W $\mathsf{ETW}$ Var 3.7' TO 8' 12′ Var DITCH "D1" DITCH "D2" 10' TO 4' OG -HMA DIKE R/W -PG FG-1:1 Sta "A" 22+90.00 TO Sta "A" 23+55.00 0.45' HMA (TYPE A) 0.70' CLASS 2 AB UVAS ROAD Sta "A" 20+64.80 TO Sta "A" 22+45.00 "A" LINE "A" LINE CONCRETE BARRIER Var 1'TO 4', HP TYPE 836 WITH TUBULAR SEE NOTE 6 12′ CONFORM 12′ R/W ETW EP HP $\mathsf{ETW}$ FL ES Var 4′ TO 8′ BICYCLE RAILING Var 3.0' 16' Typ 12' SEE | CONSTRUCTION DETAILS RETAINING -PG HMA DIKE MATCH Exist TO WALL TYPE 1 (TYPE E) -FG, SEE CONTOUR GRADING 11%-17% R/W R/W CONCRETE VALLEY GUTTER, SEE CONSTRUCTION DETAILS O.20'HMA (TYPE A) O.45' HMA (TYPE A) 0.35' CLASS 2 AB 0.45' HMA (TYPE A) 0.70' CLASS 2 AB 0.70' CLASS 2 AB UVAS ROAD UVAS ROAD Sta "A" 20+06.63 TO Sta "A" 20+64.80 Sta "A" 22+45.00 TO Sta "A" 24+64.30 BB RELATIVE BORDER SCALE O IS IN INCHES DRAWING No. UVAS CREEK BRIDGE NO. 37C0094 COUNTY OF SANTA CLARA ROADS AND AIRPORTS DEPARTMENT 05 100% SUBMITTAL KP 10/22 CD X-1REPLACEMENT AT UVAS ROAD KP 9/20 CD 04 95% SUBMITTAL REVISED K. Panayotov 9/2020 Solomon Tegegne No. 76913 KP 3/18 CD 03 95% SUBMITTAL Solomon Tigigne 8E589C3D12854E2... TYPICAL CROSS SECTIONS R. Rameriz 9/2020 02 REV 65% SUBMITTAL KP 8/14 CD Rocclia kmak Barni Roncal 3 <sub>OF</sub> 39 Exp. 12/31/24 1/18/2023 01 65% SUBMITTAL KP 10/12 CD ----B51EF92B38F54B9.. B. Grimm 9/2020 BARNI RONCAL ASSISTANT CIVIL ENGINEER SOLOMON TEGEGNE SENIOR CIVIL ENGINEER ROCELIA KMAK PRINCIPAL CIVIL ENGINEER ADVERTISEMENT DATE: CONTRACT No. BY DATE NO SCALE REVISIONS C4328


### NOTE:

- 1. SLOPE VARIES AS FOLOWS: FROM 2:1 TO 2.5:1 FROM STA "A" 26+34.00 TO "A" 26+40.00. FROM 2.5:1 TO 3:1 FROM STA "A" 26+40.00 TO "A" 26+75.00.
- 2. UNPAVED SHOULDER WIDTH PER TYPICAL MGS LAYOUT AT STRUCTURE APPROACH AND DEPARTURE. SEE STANDARD PLANS A7702 AND RSP A7704.




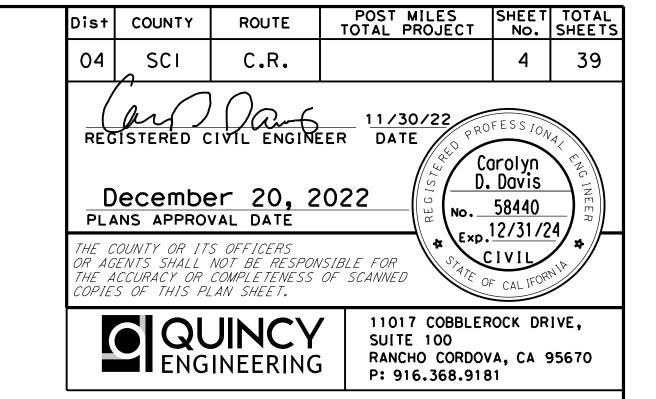

Sta "A" 26+75.00 TO Sta "A" 29+35.09

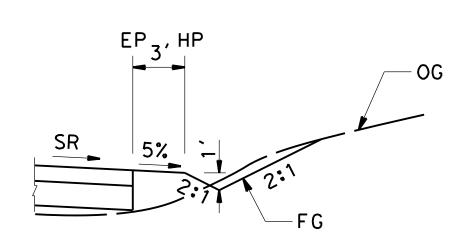

Sta "A" 26+90.00 TO Sta "A" 29+35.09

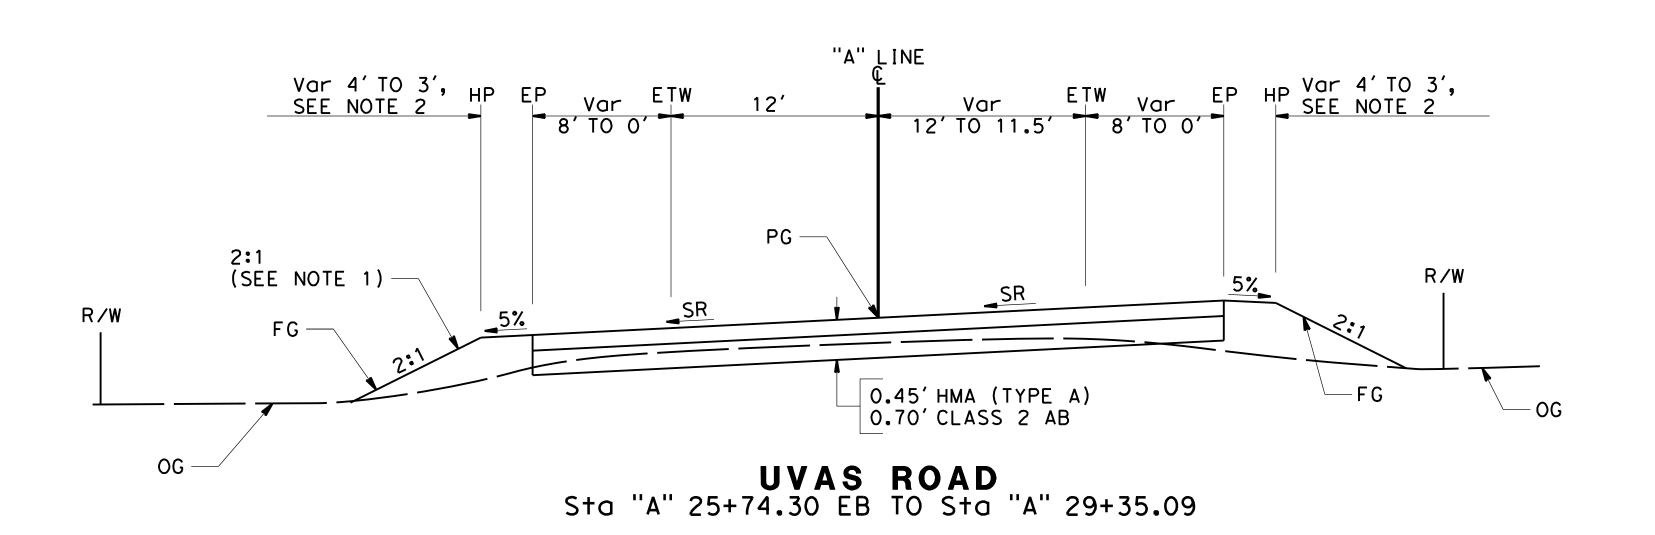


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ent	04	95% SUBMITTAL REVISED	KP	9/20	CD
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LE	NO.	REVISIONS	BY	DATE	APP'D



COUNT	Y OF	SAI
K December	0.40000	SUBMI
K. Panayotov	9/2020	
DESIGNED	DATE	
R. Rameriz	9/2020	Do
DRAWN	DATE	$\begin{bmatrix} Day \\ 770 \end{bmatrix}$
B. Grimm	9/2020	BARNI

BARNI RONCAL ASSISTANT CIVIL ENGINEER	ROCELIA KMAK PRINCIPAL CIVIL ENGINEER
DocuSigned by: Barni Roncal 77061EF45E4643E	Pocusigned by: Rowlia temak B51EF92B38F54B9
SUDWITTED.	REVIEWED.

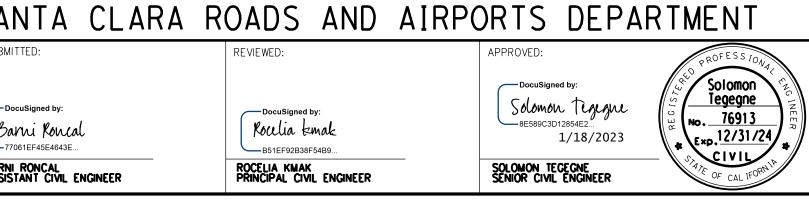

UVAS	CREEK	BRIDGE	NO.	3700094
REI	PLACEM	ENT AT	UVAS	ROAD

TYPICAL	CROSS	SECTIONS
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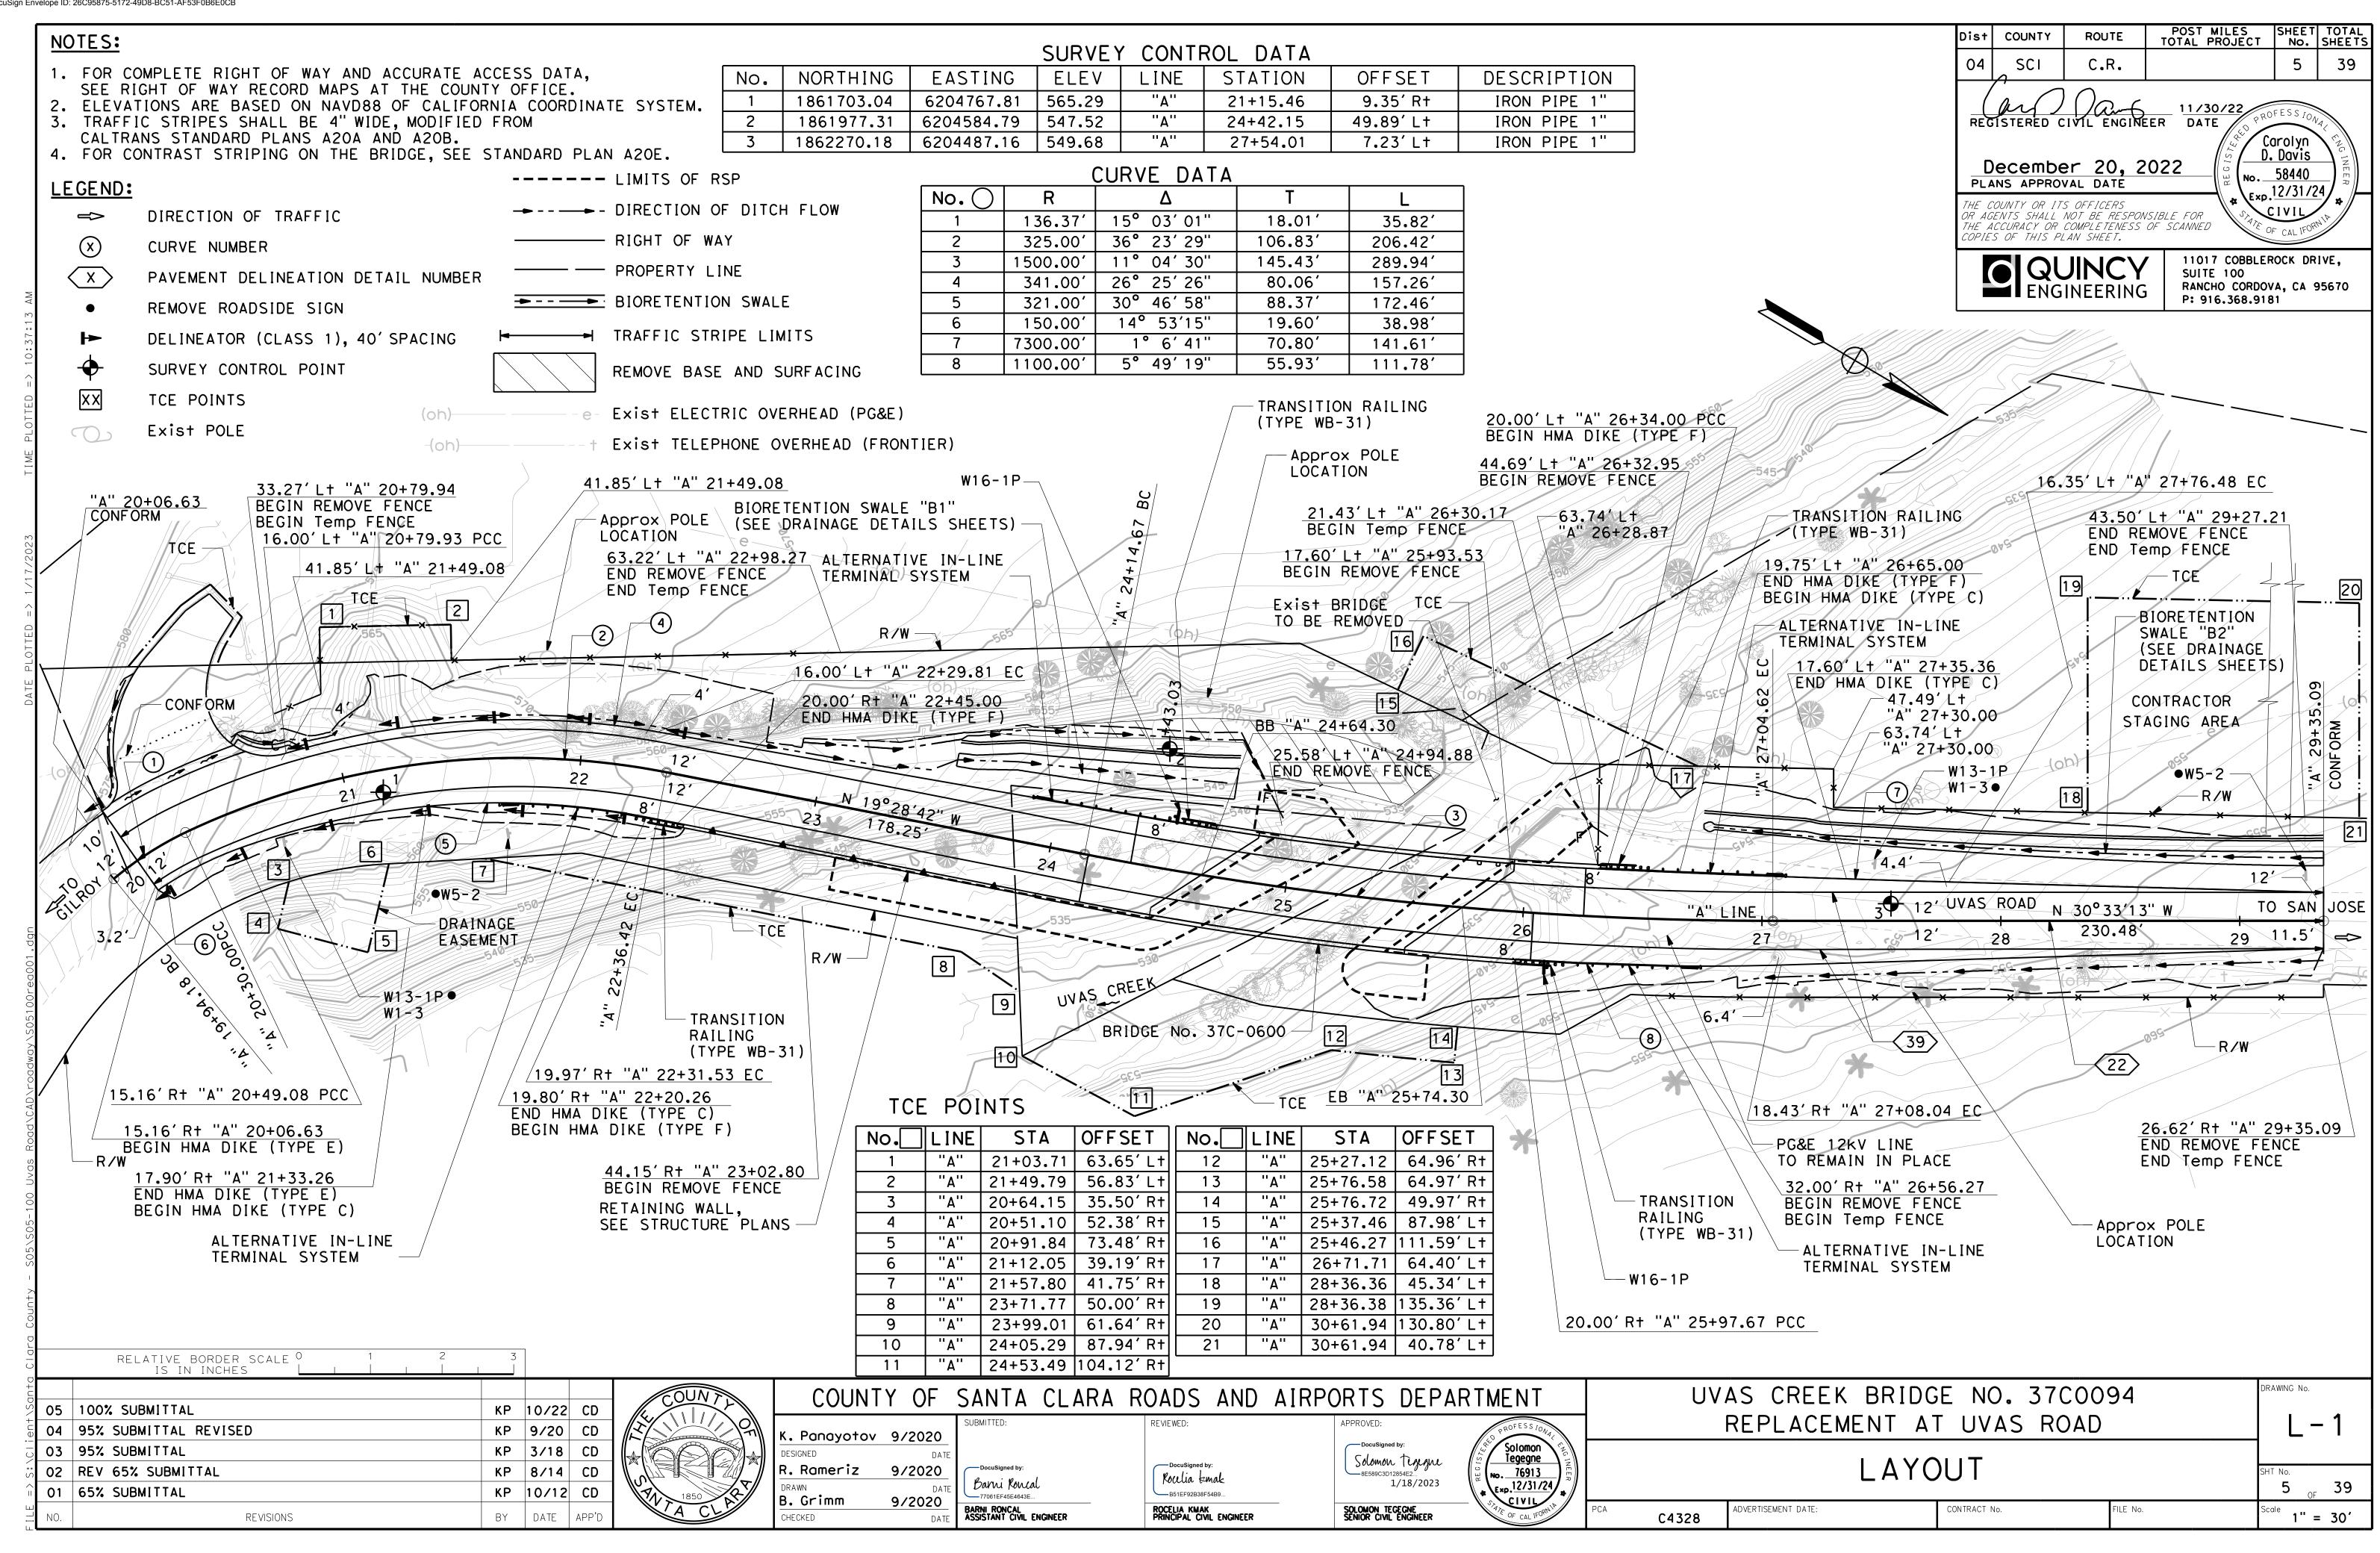
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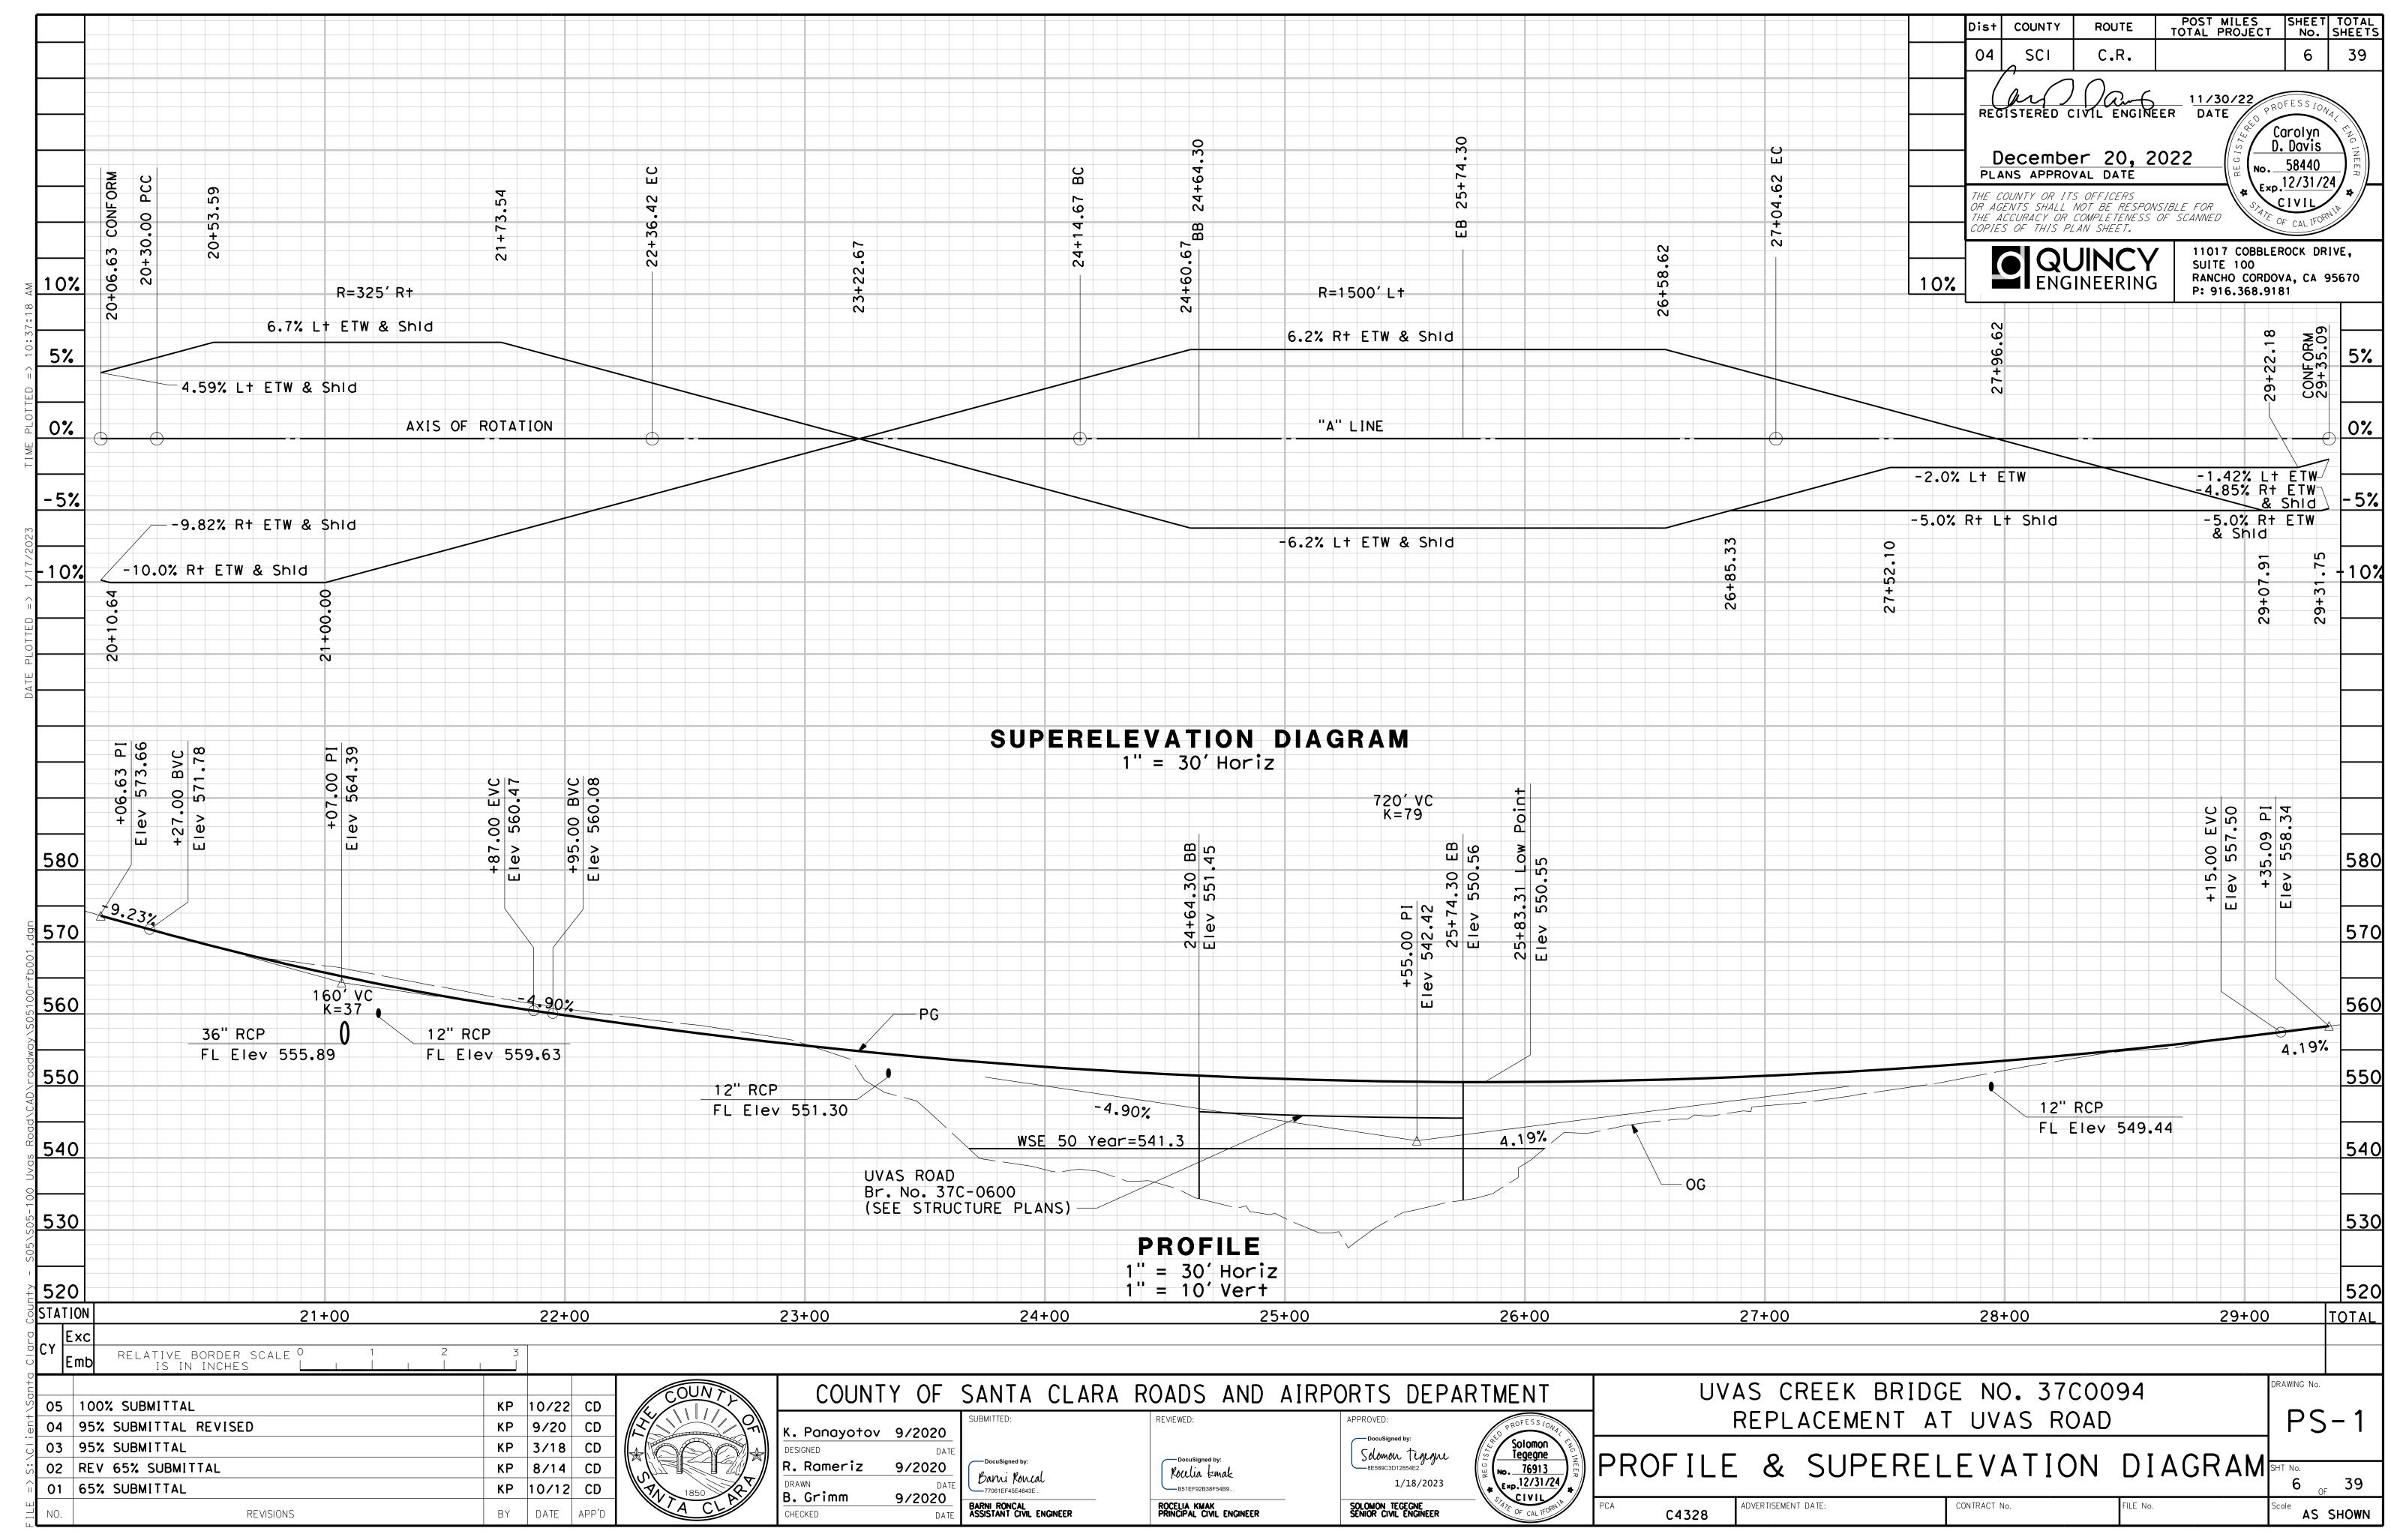
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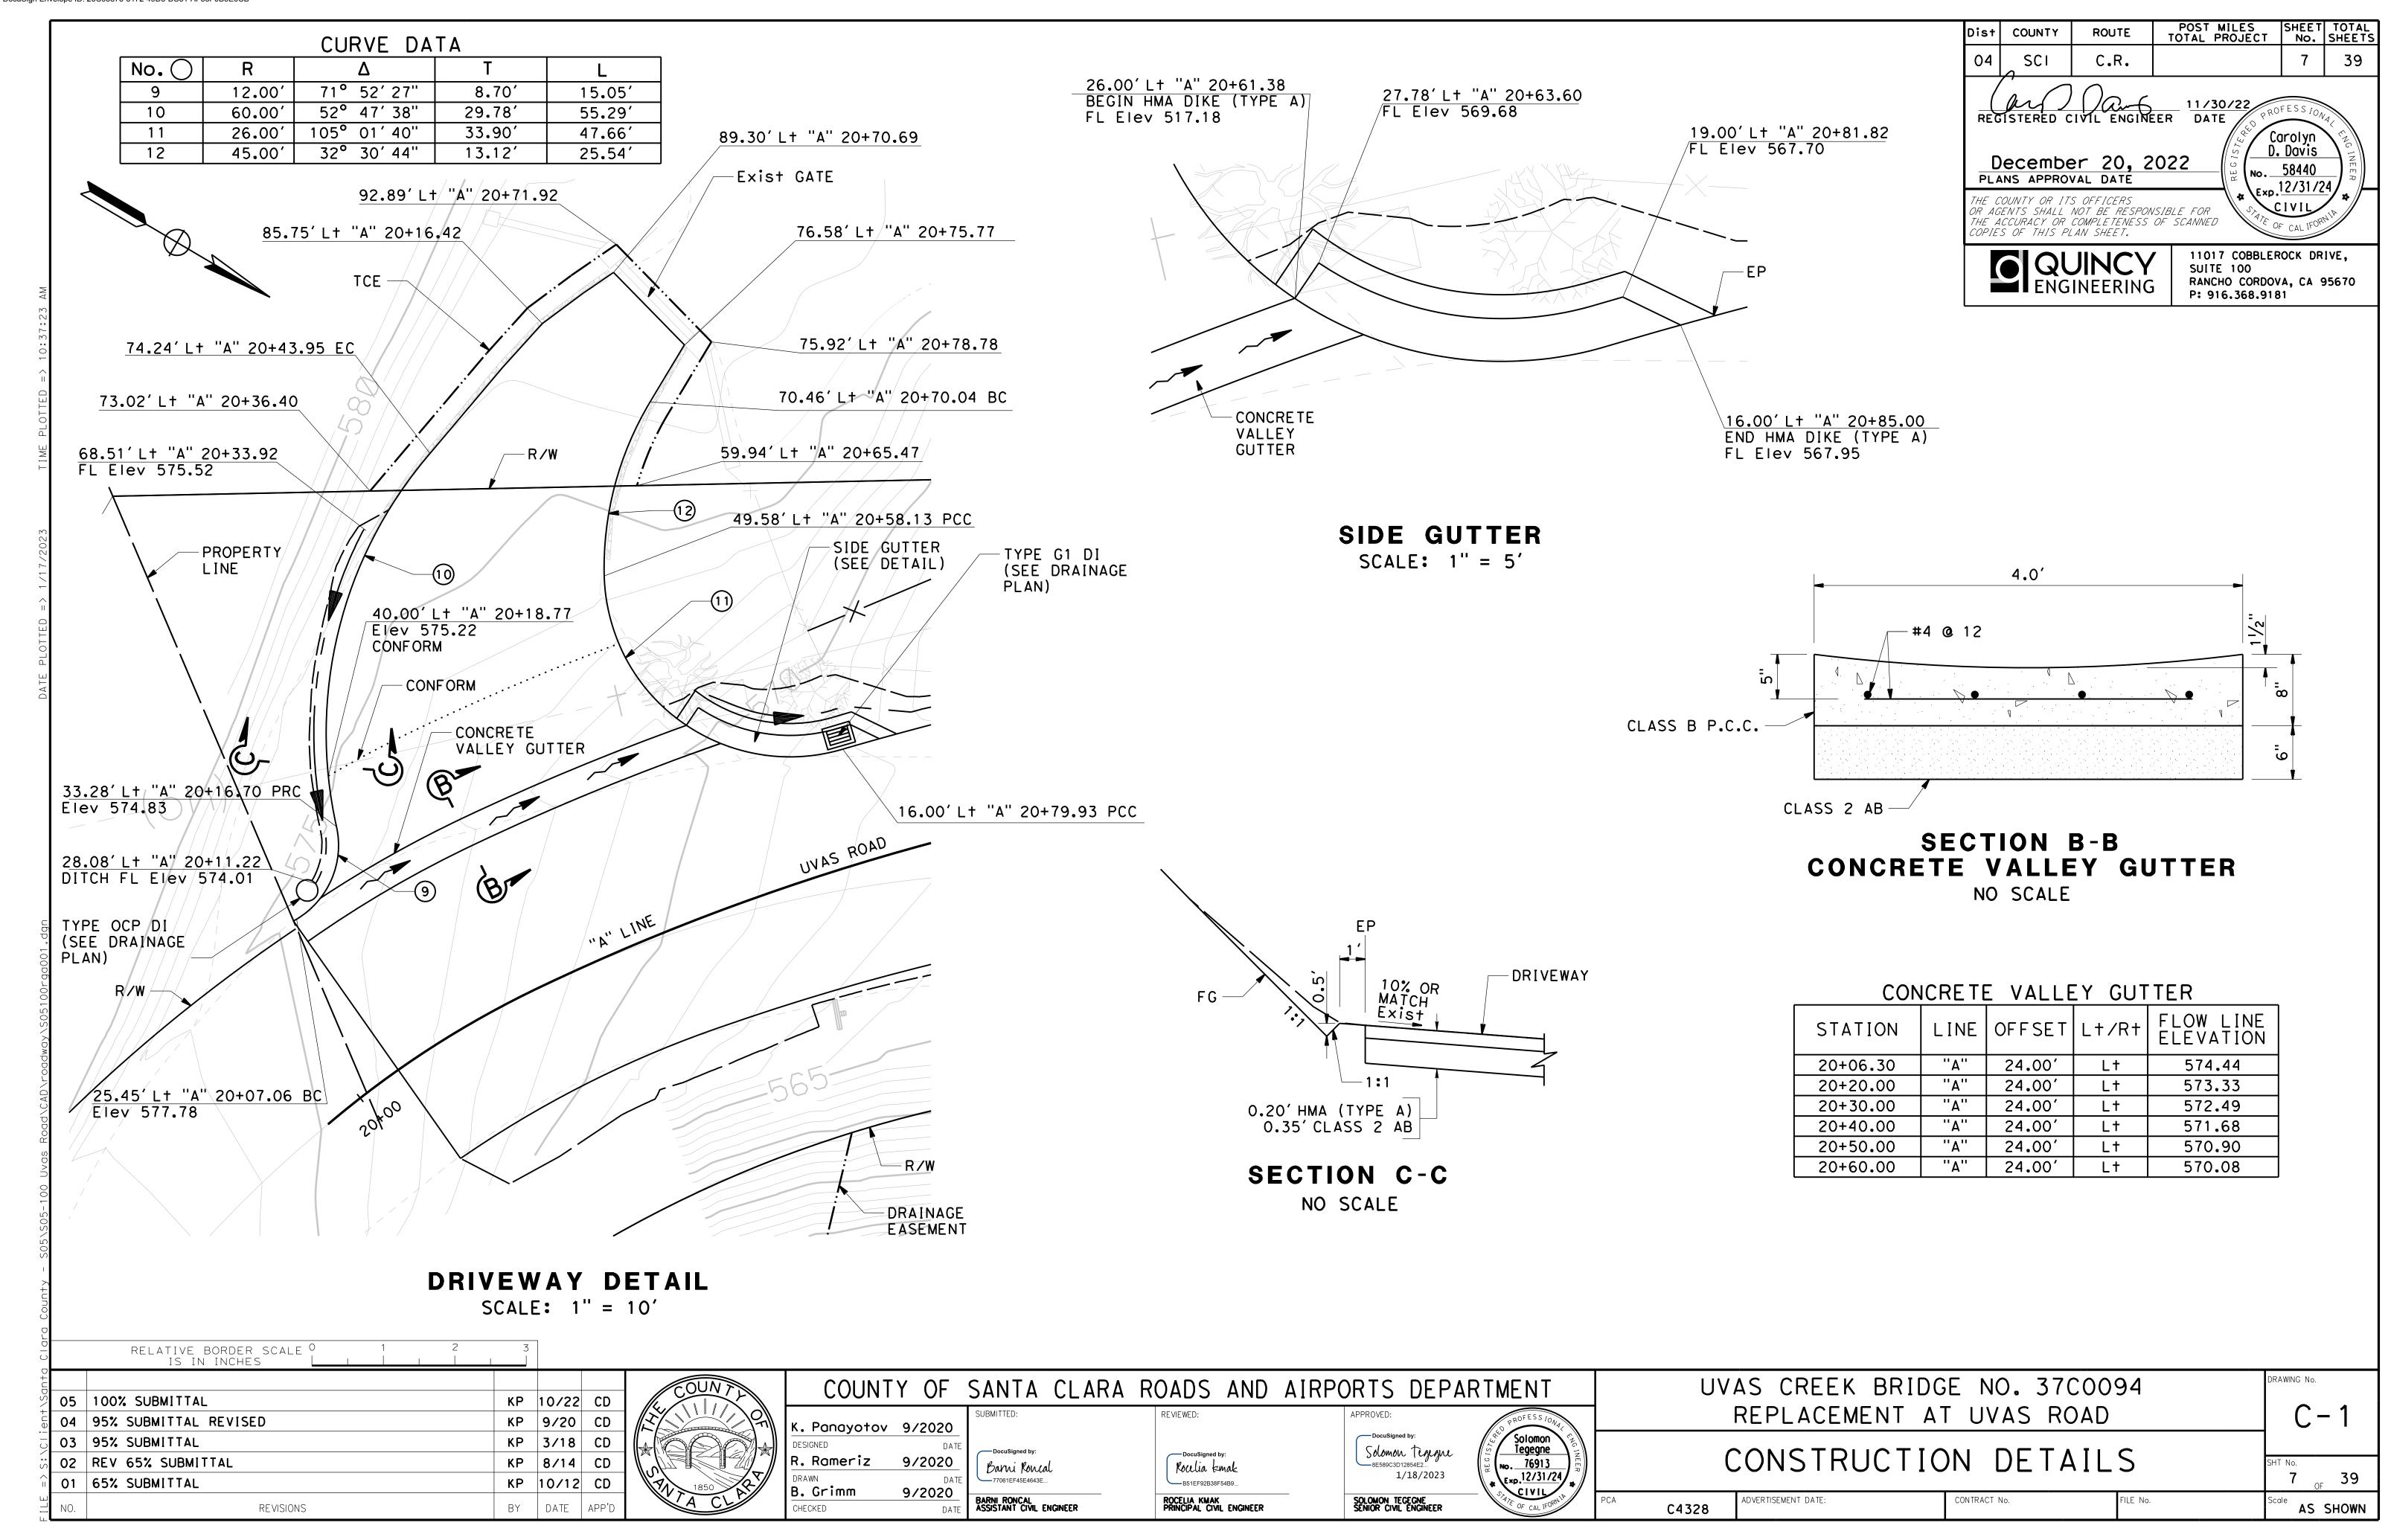
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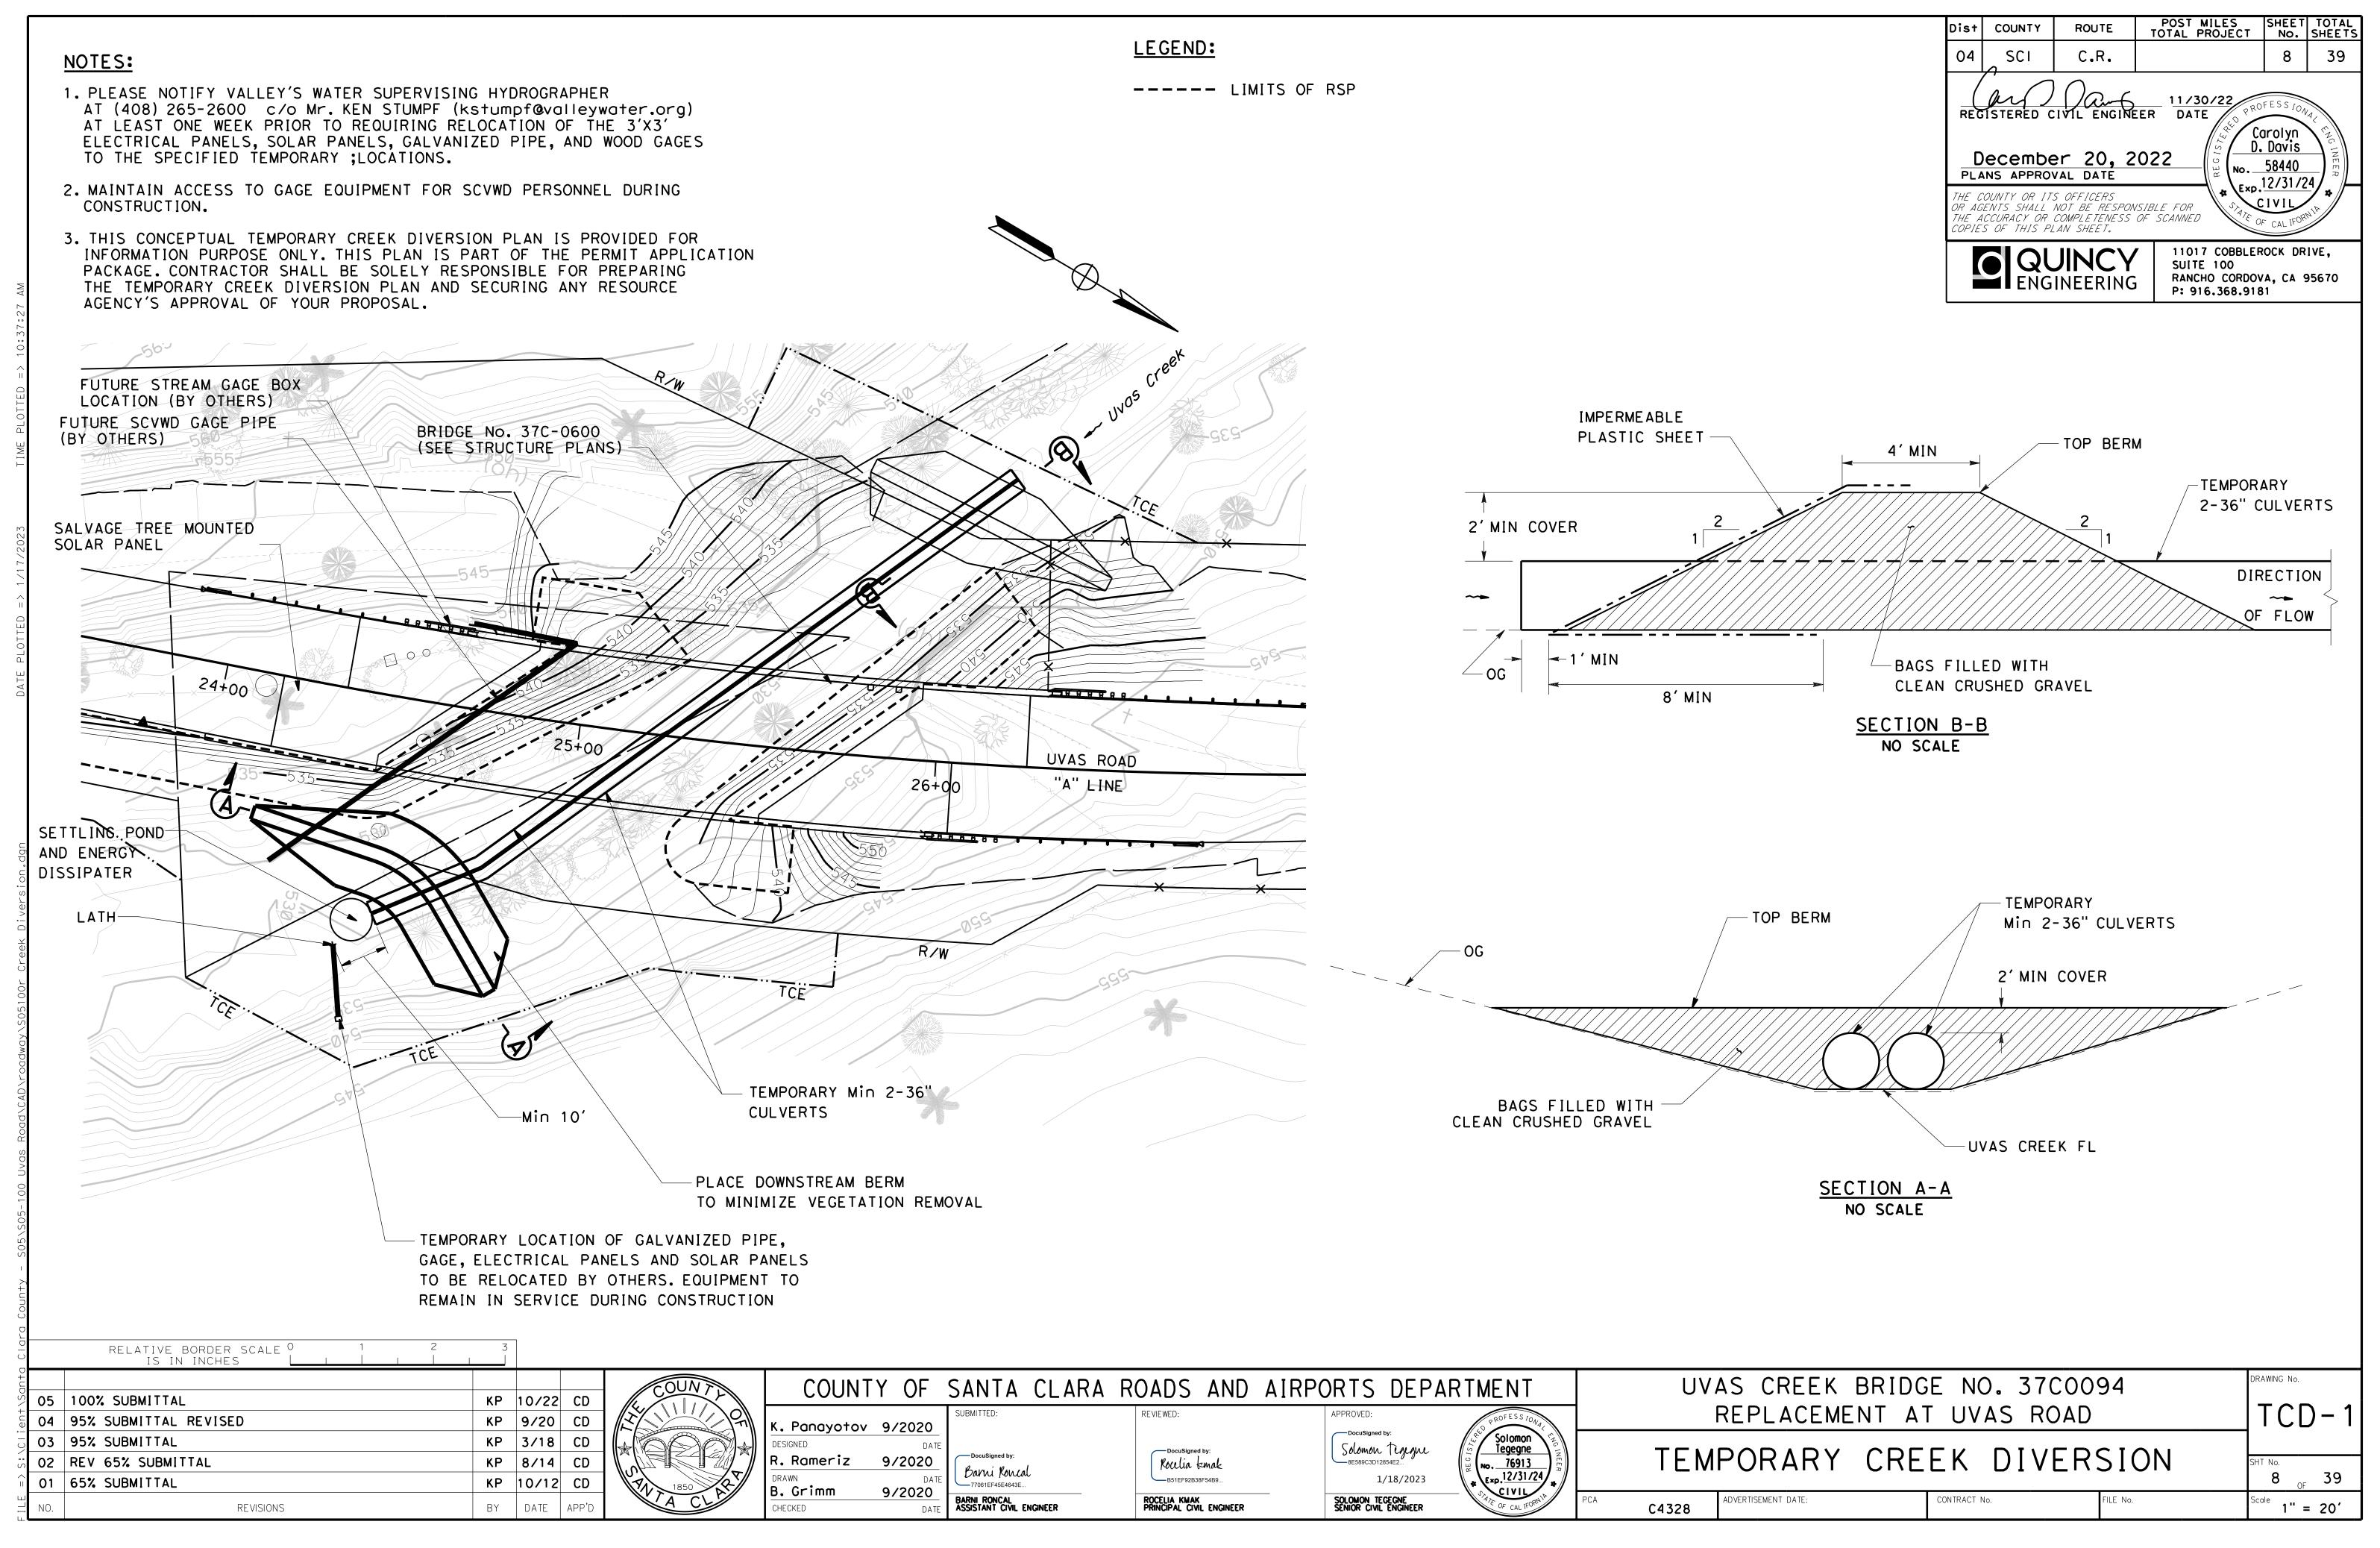
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SEQUENCE	ITEM	MATE	RIAL	APPLICATION	DEPTH	REMARKS
SEQUENCE	I I C IVI	DESCRIPTION	TYPE	RATE		REMARKS
STEP 1	BIORETENTION SOIL MEDIA	BIORETENTION SOIL MEDIA	-	-	18"	
STED 2	HYDROSEED	SEED	MIX 1	40 LB/ACRE		
STEP 2 HYDR	HTUROSEED	FERTILIZER	ORGANIC	600 LB/ACRE	_	
STEP 3	HYDROMULCH	TACKIFIER	PLANT BASED	200 LB/ACRE	-	
STEP 4	ROLLED EROSION CONTROL PRODUCT (BLANKET) (RECP)	BLANKET	TYPE A	-	-	SURFACE AREA: B1 = 2,195 SF B2 = 3,465 SF
STEP 5	FIBER ROLLS	RICE STRAW FILLED AND JUTE COVERED	8 TO 10 INCHES IN Dia	-	-	INSTALLATION TYPE 2 / LENGTH: B1 = 117 LF B2 = 260 LF

### SEED MIX 1


BOTANICAL NAME (COMMON NAME)	PERCENT GERMINATION (MINIMUM)	POUNDS PURE LIVE SEED PER ACRE (SLOPE MEASUREMENT)
BROMUS CARINATUS (CALIFORNIA BROME)	85	6
CAREX BARBARAE (SANTA BARBARA SEDGE)	70	5
ELYMUS GLAUCUS (WILD RYE)	80	6
FESTUCA CALIFORNICA (CALIFORNIA FESCUE)	60	1.5
HORDEUM BRACHYANTHERUM (MEADOW BARLEY)	75	8.5
JUNCUS PATENS (COMMON RUSH)	70	5
MELICA CALIFORNICA (CALIFORNIA ONIONGRASS)	60	4
NASSELIA PULCHRA (PURPLE NEEDLEGRASS)	70	4

### **EROSION CONTROL TYPE 2**

SEQUENCE	ITEM	MATE	RIAL	APPLICATION	DEPTH	REMARKS					
SEQUENCE	I I C M	DESCRIPTION	TYPE	RATE	DEFIR	REMARKS					
STEP 1	HYDROSEED	SEED	MIX 2	45 LB/ACRE	_						
SIEF I	HIDROSEED	FERTILIZER	ORGANIC	600 LB/ACRE	_						
STEP 2	HYDROMULCH	TACKIFIER	PLANT BASED	200 LB/ACRE	-						
STEP 3	ROLLED EROSION CONTROL PRODUCT (BLANKET)	BLANKET	TYPE A	-	-						
STEP 4	FIBER ROLLS	RICE STRAW FILLED AND JUTE COVERED	8 TO 10 INCHES IN Dia	1	-						

### NOTE:

1. FOR KEY TRENCH DETAIL, SEE STANDARD PLAN H52, DETAIL C.

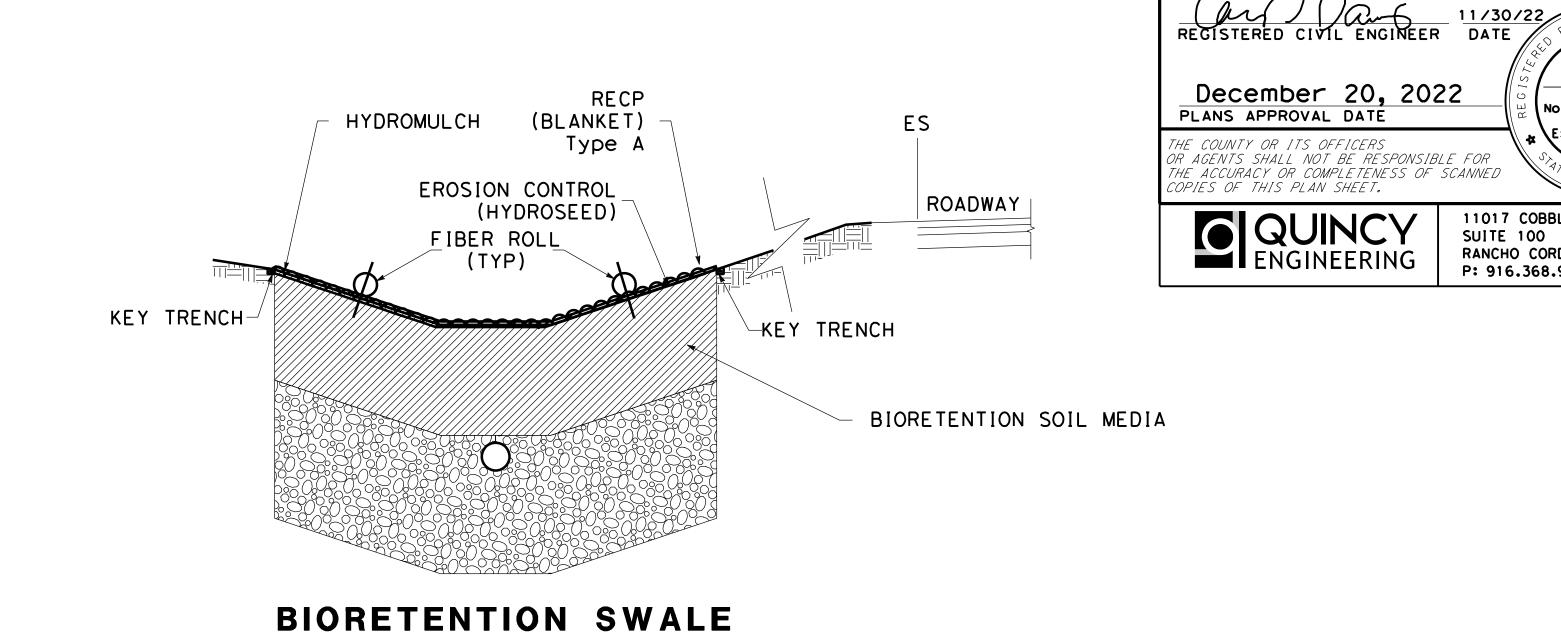

### SEED MIX 2 POUNDS PURE LIVE PERCENT GERMINATION BOTANICAL NAME SEED PER ACRE (COMMON NAME) (MINIMUM) (SLOPE MEASUREMENT) ACHILLEA MILLEFOLIUM 5 (WHITE YARROW) ESCHSCHOLZIA CALIFPRNICA 85 10 (CALIFORNIA POPPY) LAYIA PLATYGLOSSA 85 5 (TIDY TIPS) LINUM GRADIFLORUM VAR. RUBRIM (SCARLET FLAX) LUPINUS MICROCARPUS 85 15 (GOLDEN LUPINE) 45 2 DEER GRASS

### RELATIVE BORDER SCALE <sup>0</sup> IS IN INCHES 05 100% SUBMITTAL KP 10/22 CD 04 95% SUBMITTAL REVISED KP 9/20 CD KP 3/18 CD 03 95% SUBMITTAL 02 REV 65% SUBMITTAL KP 8/14 CD 01 65% SUBMITTAL KP 10/12 CD BY DATE

REVISIONS



VT	
9	κ.
	DES
	R.
\\\\\\\\\\\\\\\\\\\\\\\\\\\\\\\\\\\\\\	DR <i>A</i>
-	В.

	COU
1911	K. Panayo
	DESIGNED
	R. Romeri
\\\\\\\\\\\\\\\\\\\\\\\\\\\\\\\\\\\\\\	DRAWN <b>B.</b> Grimm

COUNT	Y OF	SANTA	CLARA	ROADS	AND	AIRPORTS	DEPARTMENT
		SUBMITTED:		REVIEWED:		APPROVED:	ROFESS 10.
Panayotov	9/2020					Desugia	NA CONAC
GNED	DATE					DocuSig	
Rameriz	9/2020	DocuSigned by:		Rowlia	•		on tygue $\begin{pmatrix} S \\ S \\ No. \\ 76913 \end{pmatrix}$
/N1	D 4 TC	Barni Ronca	L	Noucum t	anue		$1/18/2023$ $^{\circ}$ $\frac{12/31/24}{1}$

DocuSigned by: Barni Roncal BARNI RONCAL ASSISTANT CIVIL ENGINEER

Roculia Emak ROCELIA KMAK PRINCIPAL CIVIL ENGINEER

Solomon Tegegne No. 76913 Solomon Tigigue
8E589C3D12854E2... Exp. 12/31/24 1/18/2023 SOLOMON TEGEGNE SENIOR CIVIL ENGINEER

UVAS CREEK BRIDGE NO. 37C0094 REPLACEMENT AT UVAS ROAD

EROSION CONTROL LEGEND

ADVERTISEMENT DATE:

C4328

IECL-1 9 <sub>OF</sub> 39

CONTRACT No.

AS SHOWN

DRAWING No.

THE COUNTY OR ITS OFFICERS OR AGENTS SHALL NOT BE RESPONSIBLE FOR THE ACCURACY OR COMPLETENESS OF SCANNED COPIES OF THIS PLAN SHEET. ENGINEERING

Dist

04

COUNTY

SUITE 100

11017 COBBLEROCK DRIVE, RANCHO CORDOVA, CA 95670 P: 916.368.9181

POST MILES SHEET TOTAL TOTAL PROJECT No. SHEETS


Carolyn D. Davis

Exp. 12/31/24

No. 58440

(FOR ADDITIONAL DETAILS SEE SHEET DD-4)

NO SCALE

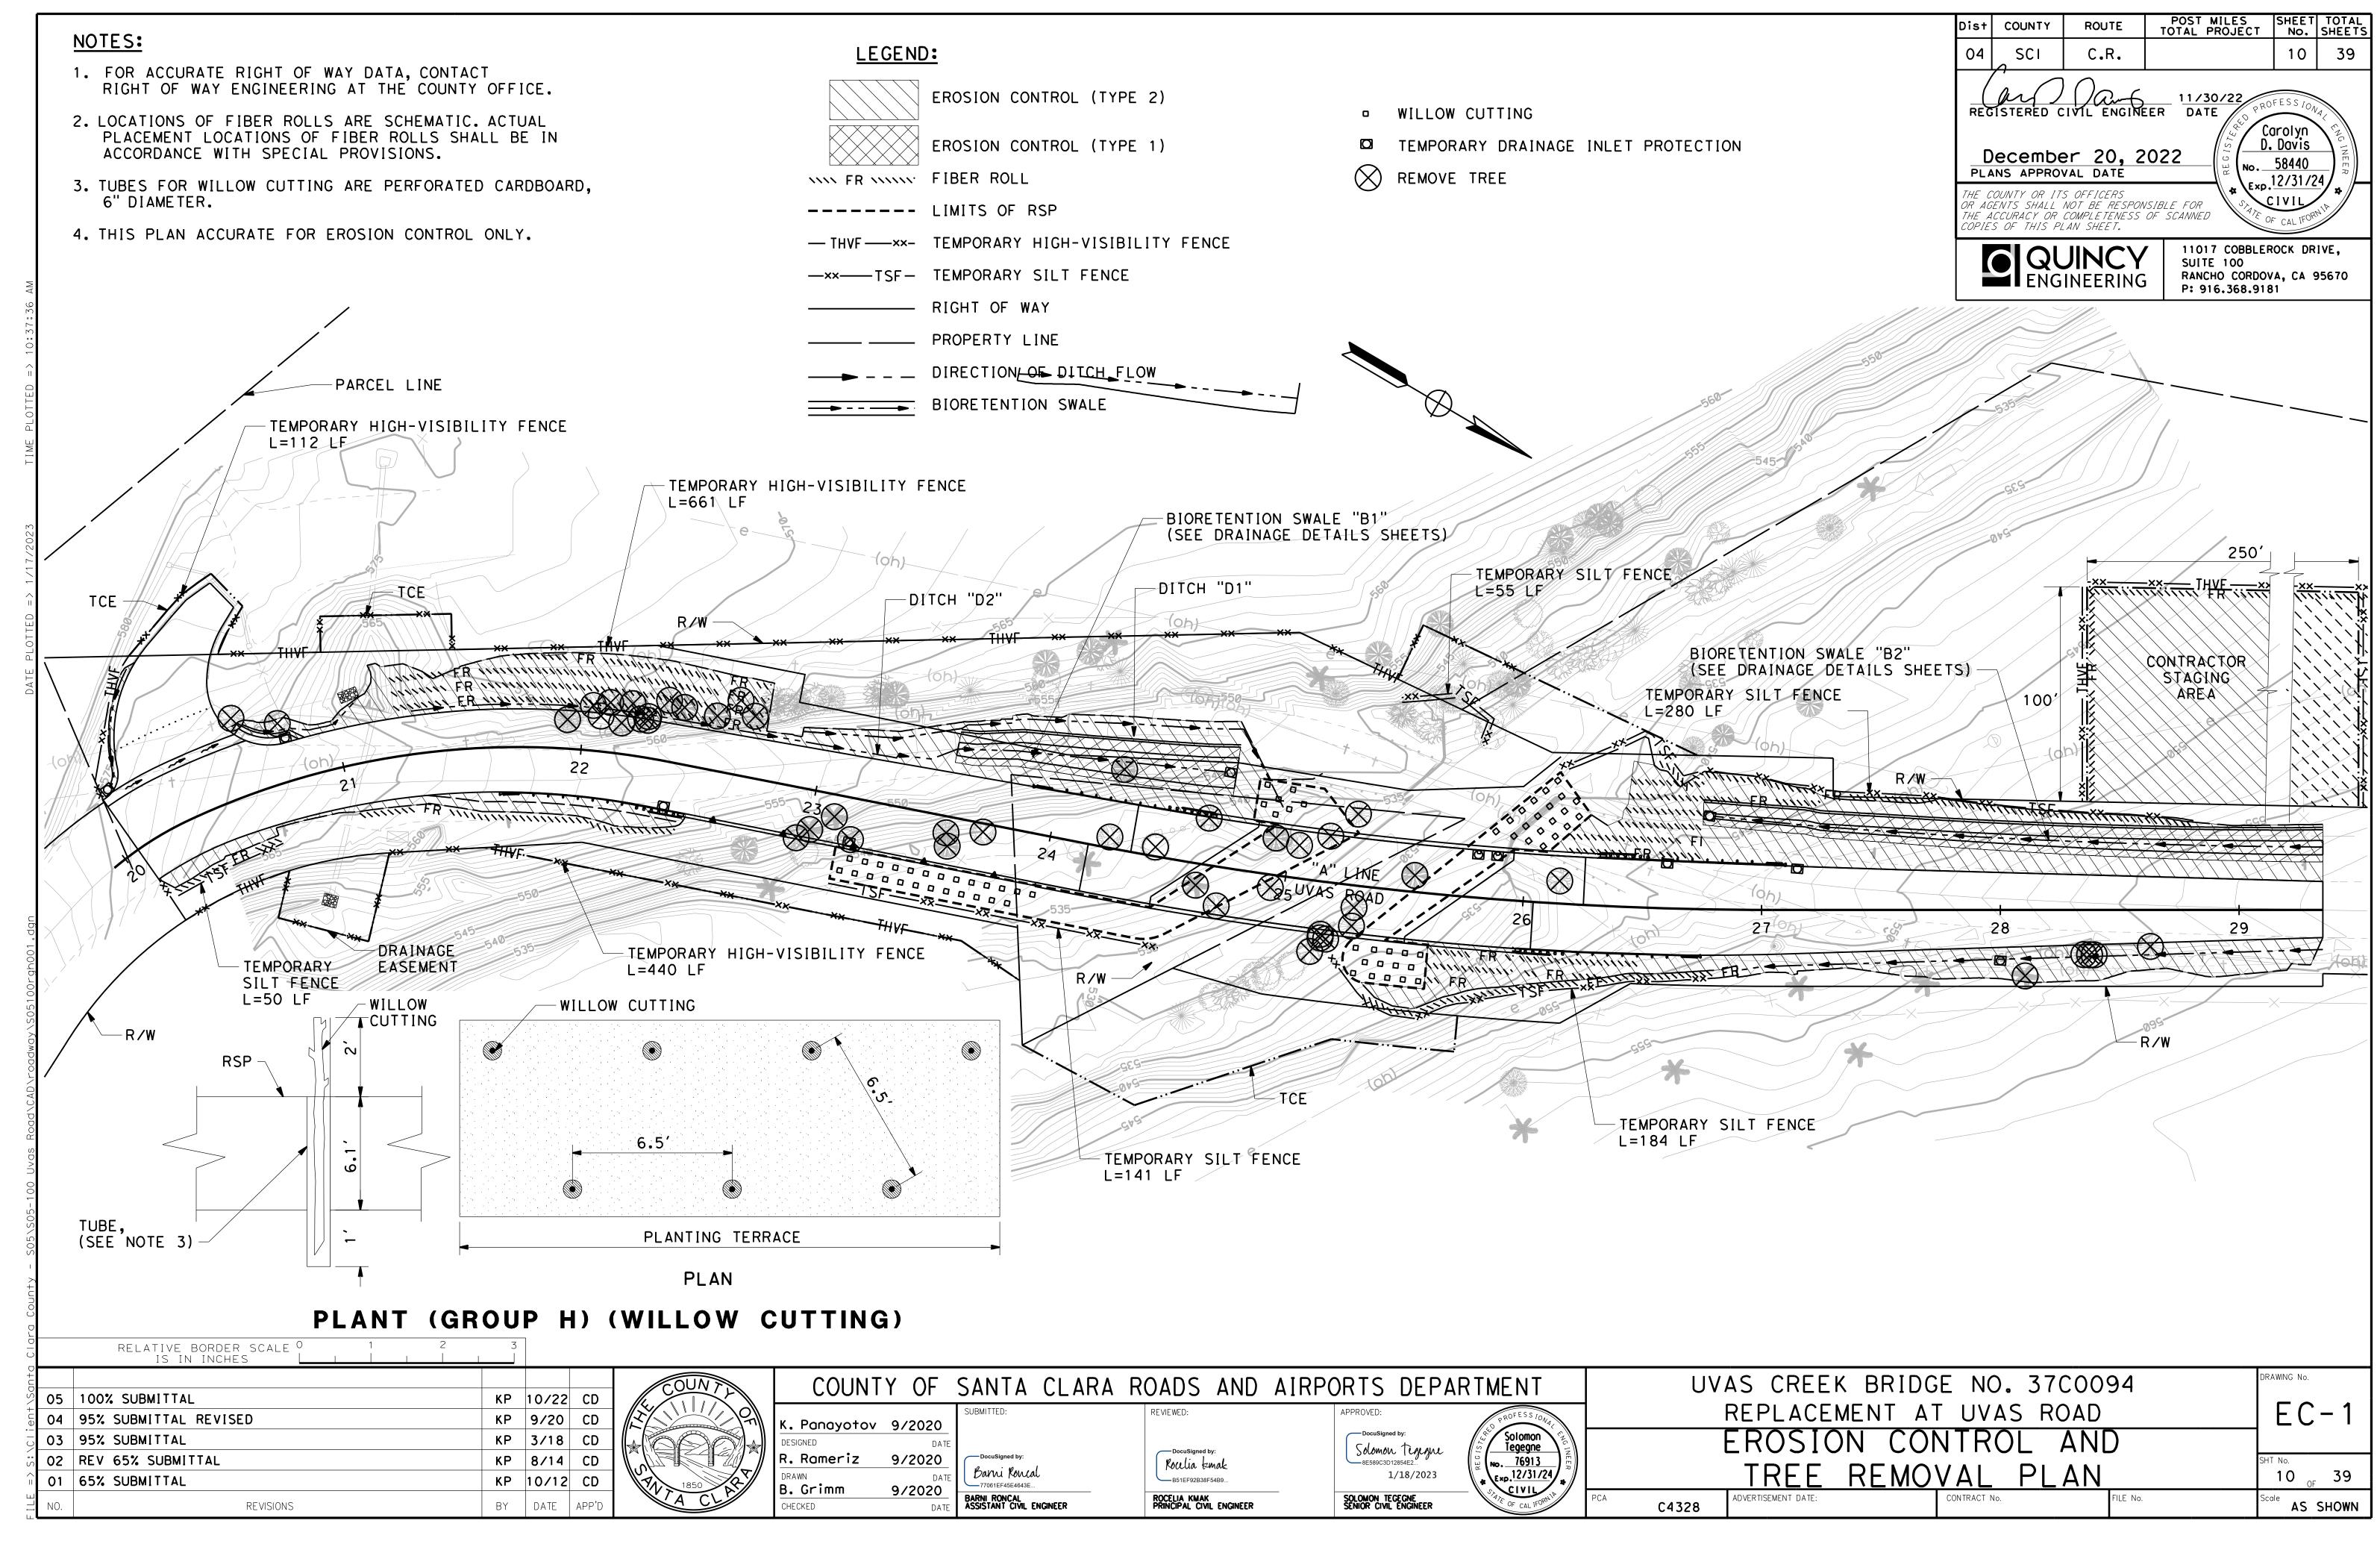

Dist	COUNTY	ROUTE	1	POST MILES OTAL PROJECT	SHEET No.	TOTAL SHEETS					
04	SCI	C.R.			11	39					
December 20, 2022  PLANS APPROVAL DATE  11/30/22  PLANS APPROVAL DATE  11/30/22  Carolyn  D. Davis  No. 58440											
OR AG THE A	THE COUNTY OR ITS OFFICERS OR AGENTS SHALL NOT BE RESPONSIBLE FOR THE ACCURACY OR COMPLETENESS OF SCANNED COPIES OF THIS PLAN SHEET.										
	Q Q ENG	JINCY INEERING		11017 COBBLER SUITE 100 RANCHO CORDOV P: 916.368.918	A, CA S						

## EROSION CONTROL QUANTITIES

SHEET No.		FROM			TO		PLANT (GROUP H) (WILLOW CUTTING)	TEMPORARY DRAINAGE INLET PROTECTION	BIOFILTRATION SOIL MEDIA	CLASS 2 PERMEABLE MATERIAL	TEMPORARY HIGH-VISIBILITY FENCE	TEMPORARY SILT FENCE	FIBER ROLLS	ROLLED EROSION CONTROL PRODUCT (BLANKET)	HYDROMULCH	HYDROSEED MIX 1	HYDROSEED MIX 2
	LINE	STATION	L+/R+	LINE	STATION	L+/R+	EΑ	EΑ	CY	CY	LF	LF	LF	SQFT	SQFT	SQFT	SQFT
EC-1	"A"	20+11	L†	"A"	20+38	L†		1						130	130		130
EC-1	"A"	20+07	R†	"A"	22+48	R†		1					183	1297	1297		1297
EC-1	"A"	20+60	L†	"A"	24+83	L†		2					585	7474	7474		7474
EC-1	"A"	23+55	L†	"A"	24+73	L†			172	361			234	1955	1955	1955	
EC-1	"A"	23+12	R†	"A"	23+98	R†	25	1									
EC-1	"A"	24+83	L†	"A"	25+00	L†	7										
EC-1	"A"	25+30	R†	"A"	25+62	R†	14										
EC-1	"A"	25+36	R†	"A"	29+35	R†		1					359	4606	4606		4606
EC-1	"A"	25+85	L†	"A"	26+25	L†	20										
EC-1	"A"	26+10	L†	"A"	29+35	L†		3					567	5728	5728		5728
EC-1	"A"	26+75	L†	"A"	29+35	L†			253	336			512	2986	2986	2986	
EC-1	"A"	20+07	L†	"A"	20+70	L†					112						20615
EC-1	"A"	20+78	L†	"A"	25+94	L†					661						
EC-1	"A"	20+07	R†	"A"	23+99	R†					440						
EC-1		NG AREA	L†								450		321	20615	20615		
EC-1	"A"	20+11	R†	"A"	20+64	R†						50					
EC-1	"A"	23+12	R†	"A"	24+50	R†						141					
EC-1	"A"	25+40	L†	"A"	25+78	L†						55					
EC-1	"A"	25+30	R†	"A"	26+90	R†						184					
EC-1	"A"	26+12	L†	"A"	28+80	<u>L</u> †						280					
EC-1	BRIDGE		L†					2									
						TOTAL	66	11	425	697	1663	710	2761	44791	44791	4941	39850

フ    - 		RELATIVE BORDER SCALE <sup>O</sup> 1 2 IS IN INCHES <u>L. J. J. J.</u>	3		
701	05	100% SUBMITTAL	KP	10/22	CD
ב ט	04	95% SUBMITTAL REVISED	KP	9/20	CD
ے ا	03	95% SUBMITTAL	KP	3/18	CD
·	02	REV 65% SUBMITTAL	KP	8/14	CD
\	01	65% SUBMITTAL	KP	10/12	CD
	NO.	REVISIONS	BY	DATE	APP'D



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WY TA	1850

9	K. Po
	DESIGNE
	R. Ro
\\\\\\\\\\\\\\\\\\\\\\\\\\\\\\\\\\\\\\	DRAWN
50	B. Gr

COUNTY OF SANTA CLARA ROADS AND AIRPORTS DEPARTMENT Panayotov 9/2020 Rameriz 9/2020 Barni Roncal 77061EF45E4643E...

Pocusigned by:
Rowlia Emak
B51EF92B38F54B9... ROCELIA KMAK PRINCIPAL CIVIL ENGINEER

Solomon Tegegne No. 76913 Exp.12/31/24 Solomon Tigigne
8E589C3D12854E2... 1/18/2023

UVAS	CREEK	BRI	DGE	NO.	3700094
REF	PLACEME	ENT	ΑT	UVAS	ROAD
	-				

ECQ-1 EROSION CONTROL QUANTITIES


11 <sub>OF</sub> 39


ADVERTISEMENT DATE: C4328


CONTRACT No.


Scale AS SHOWN

### POST MILES SHEET TOTAL TOTAL PROJECT NO. SHEETS Dist COUNTY NOTES: LEGEND: 04 C.R. 1. THIS PLAN ACCURATE FOR CONTOUR GRADING WORK ONLY. ---- LIMITS OF RSP 2. CONTOURS SHOWN REPRESENT FINISH GRADE SURFACE. REGISTERED CIVIL ENGINEER DATE 3. FOR WILLOW CUTTING, SEE EROSION CONTROL PLAN. Carolyn D. Davis December 20, 2022 No. 58440 PLANS APPROVAL DATE $\sqrt{\text{Exp.}}\frac{12/31/24}{}$ THE COUNTY OR ITS OFFICERS OR AGENTS SHALL NOT BE RESPONSIBLE FOR THE ACCURACY OR COMPLETENESS OF SCANNED COPIES OF THIS PLAN SHEET. BRIDGE ABUTMENT FACE 11017 COBBLEROCK DRIVE, SUITE 100 RANCHO CORDOVA, CA 95670 P: 916.368.9181 OR RETAINING WALL **ENGINEERING** 21.96'L+ "A" 25+28.45 $\mathsf{OG} \overline{\ }$ SEE PLAN FOR ELEVATION 38.67' L+ "A" 25+11.53 -WILLOW CUTTING, Typ -1.5:1 OR FLATTER RSP (1/2 TON, CLASS VII, METHOD B) MATCH CONTOUR GRADING SEE PLAN 39.26' L+ "A" 24+83.63 54.97' L+ "A" 26+12.41 GRAVEL FILTER TUBE, Typ 37.87' L+ "A" 26+26.76 .4' Max OR TO BEDROCK BEDROCK R/W TYPICAL SECTIONS BEDROCK A-A RSP ON EXPOSED BEDROCK NO SCALE 24+00 BRIDGE ABUTMENT FACE OR RETAINING WALL SEE PLAN FOR ELEVATION "A" Line 26+00 27+00 -1.5:1 OR FLATTER -WILLOW CUTTING, Typ $^{'}$ TCE $-\!\!\!-$ RSP (1/2 TON, CLASS VII, METHOD B) MATCH CONTOUR GRADING SEE PLAN <sup>7</sup> 35.00′ R+ "A" 23+12.61 TYPICAL SECTIONS GRAVEL FILTER 35.25' Rt "A" 24+41.79 OHWM TUBE, Typ -4' Max TRENCH 39.97' R+ "A" 25+62.21 31.21' R+ "A" 24+54.03 **BEDROCK** 22.92' Rt "A" 25+30.46 39.96′R+ "A" 25+37.44 **BEDROCK BELOW RSP** NO SCALE PLAN NOTE: CONTOUR GRADING AND RSP LIMITS RSP SECTIONS SHOWN ARE TYPICAL FOR ALL RSP AREAS SHOWN. RELATIVE BORDER SCALE O IS IN INCHES DRAWING No. UVAS CREEK BRIDGE NO. 37C0094 COUNTY OF SANTA CLARA ROADS AND AIRPORTS DEPARTMENT 05 100% SUBMITTAL KP 10/22 CD G-1REPLACEMENT AT UVAS ROAD KP 9/20 CD 04 95% SUBMITTAL REVISED K. Panayotov 9/2020 Solomon Tegegne No. 76913 Exp. 12/31/24 03 95% SUBMITTAL KP 3/18 CD Solomon tigigne 8E589C3D12854E2... CONTOUR GRADING R. Romeriz 9/2020 02 REV 65% SUBMITTAL KP 8/14 CD Rocelia kmak Barni Roncal 1/18/2023 12 <sub>OF</sub> 39 01 65% SUBMITTAL KP 10/12 CD -- B51EF92B38F54B9.. B. Grimm 9/2020 BARNI RONCAL ASSISTANT CIVIL ENGINEER SOLOMON TEGEGNE SENIOR CIVIL ENGINEER ADVERTISEMENT DATE: CONTRACT No. 1" = 20' ROCELIA KMAK PRINCIPAL CIVIL ENGINEER BY DATE REVISIONS C4328

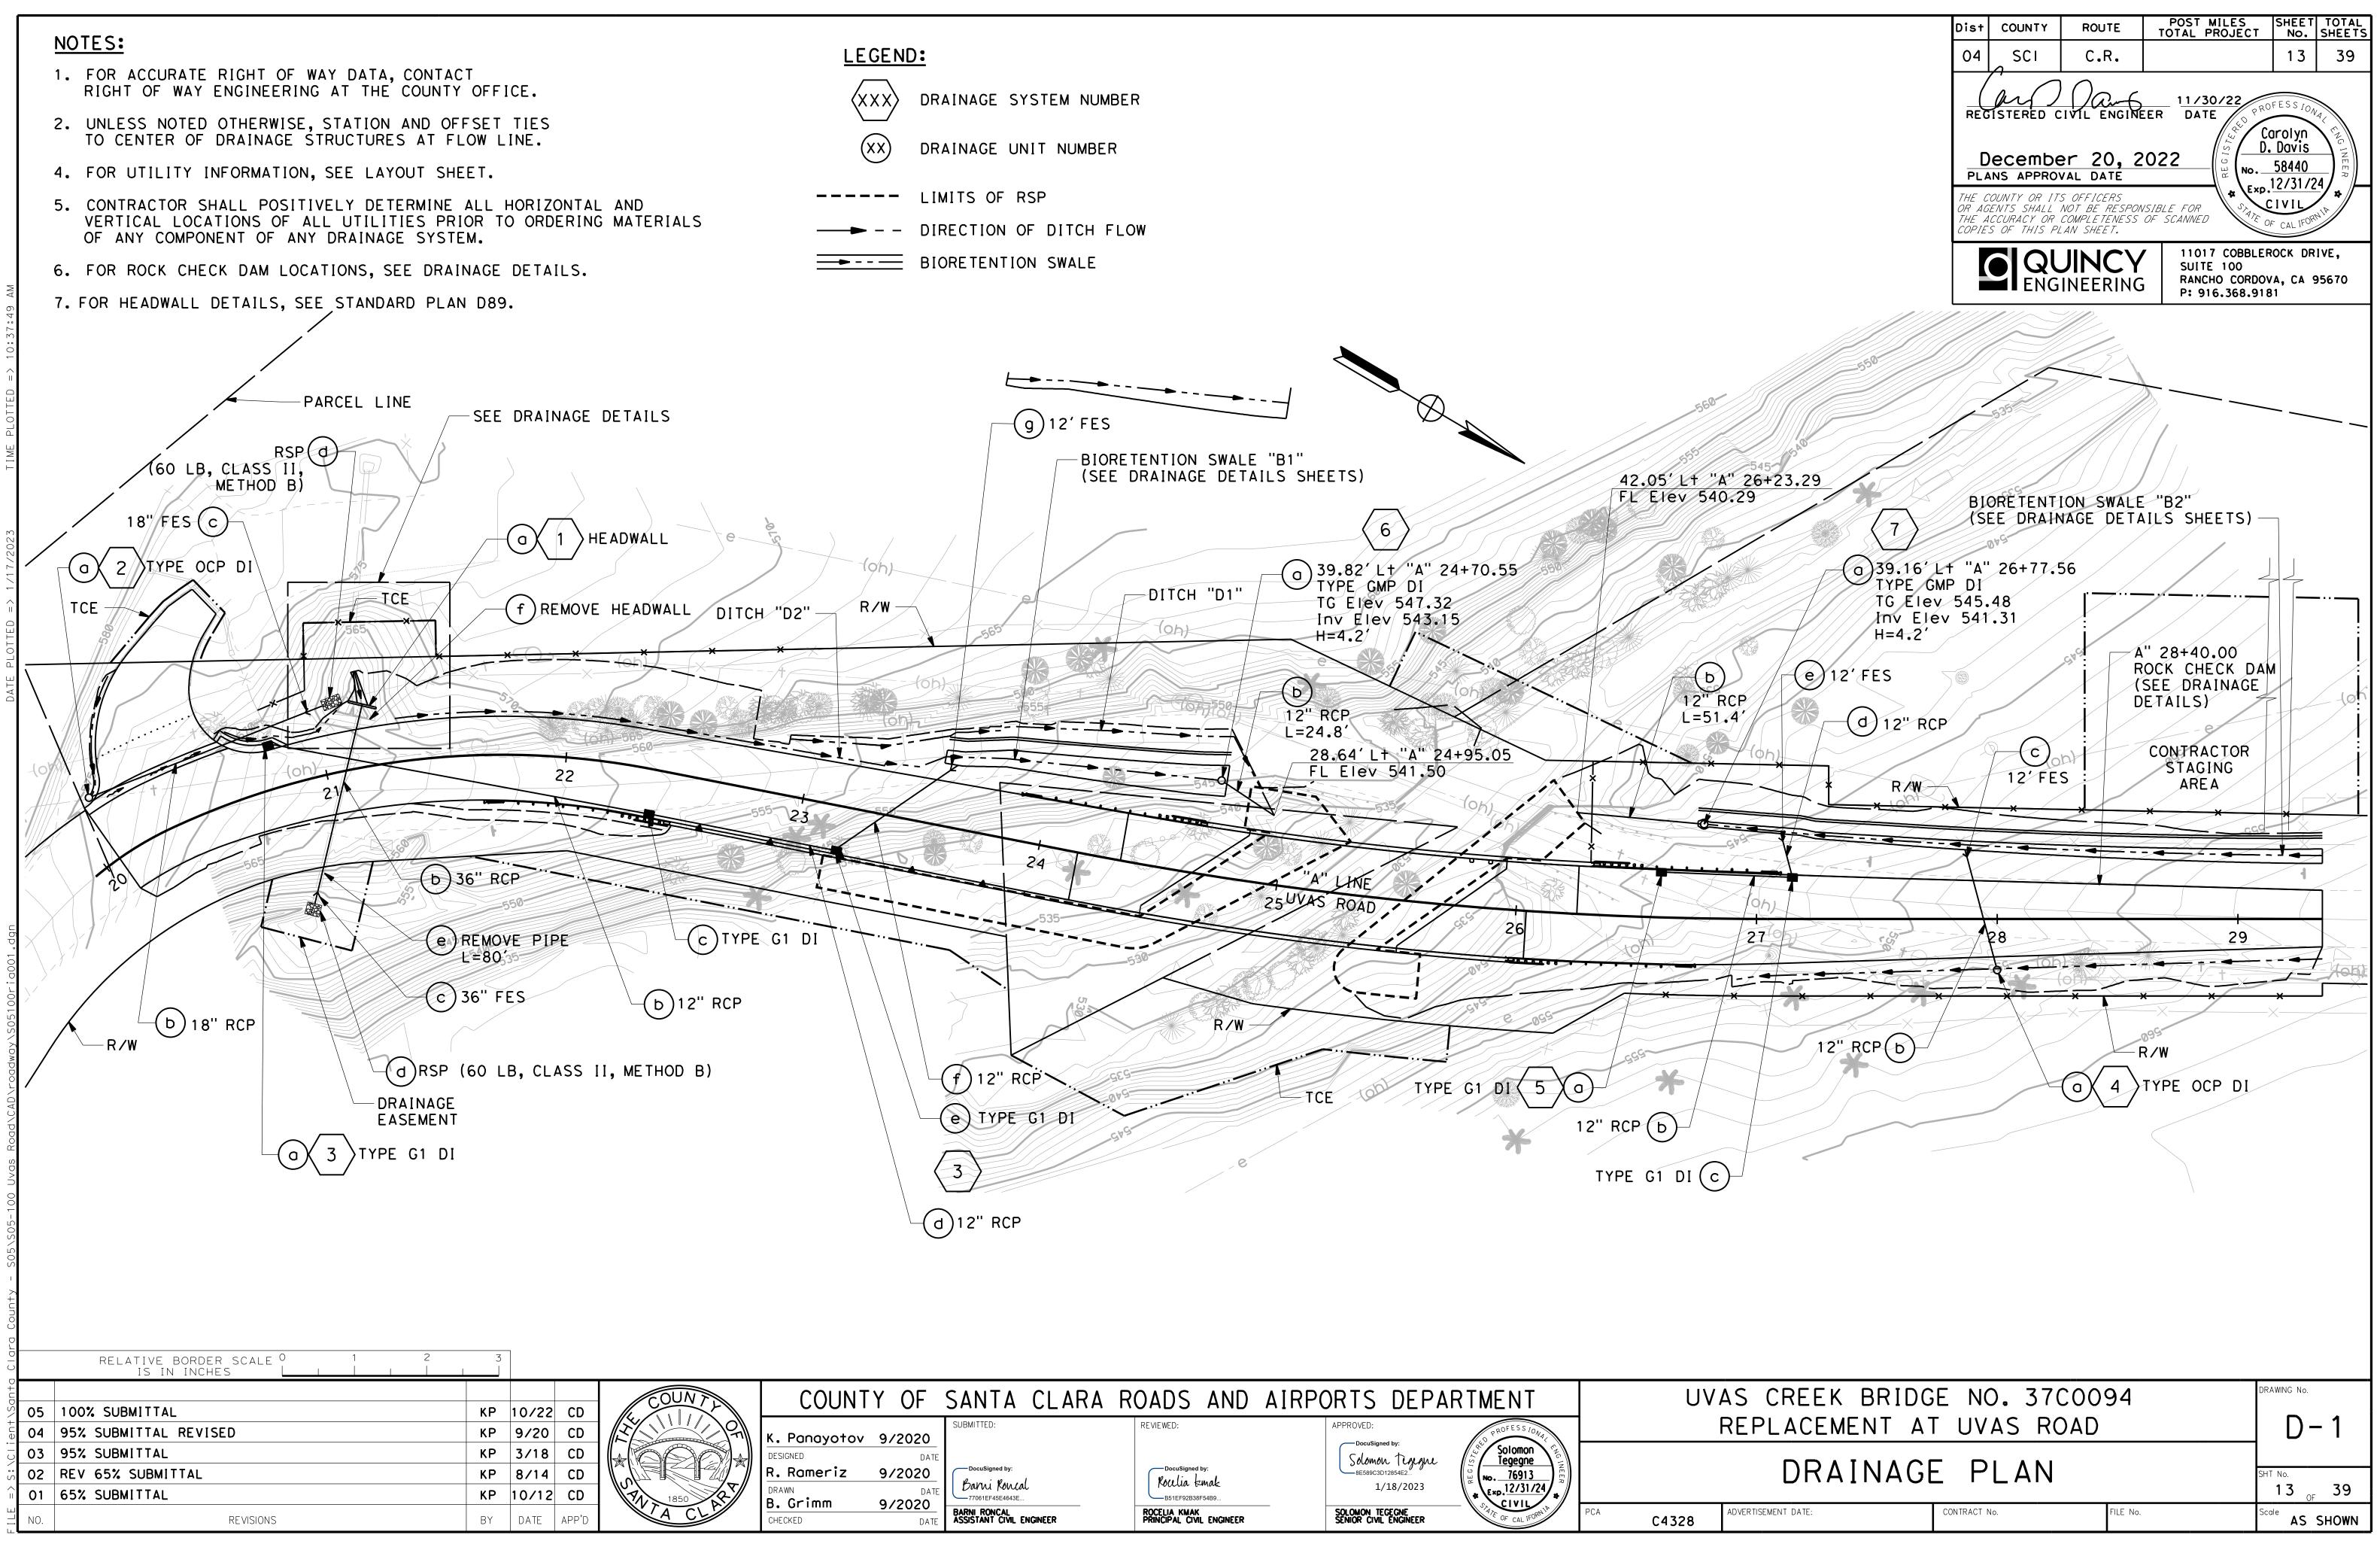

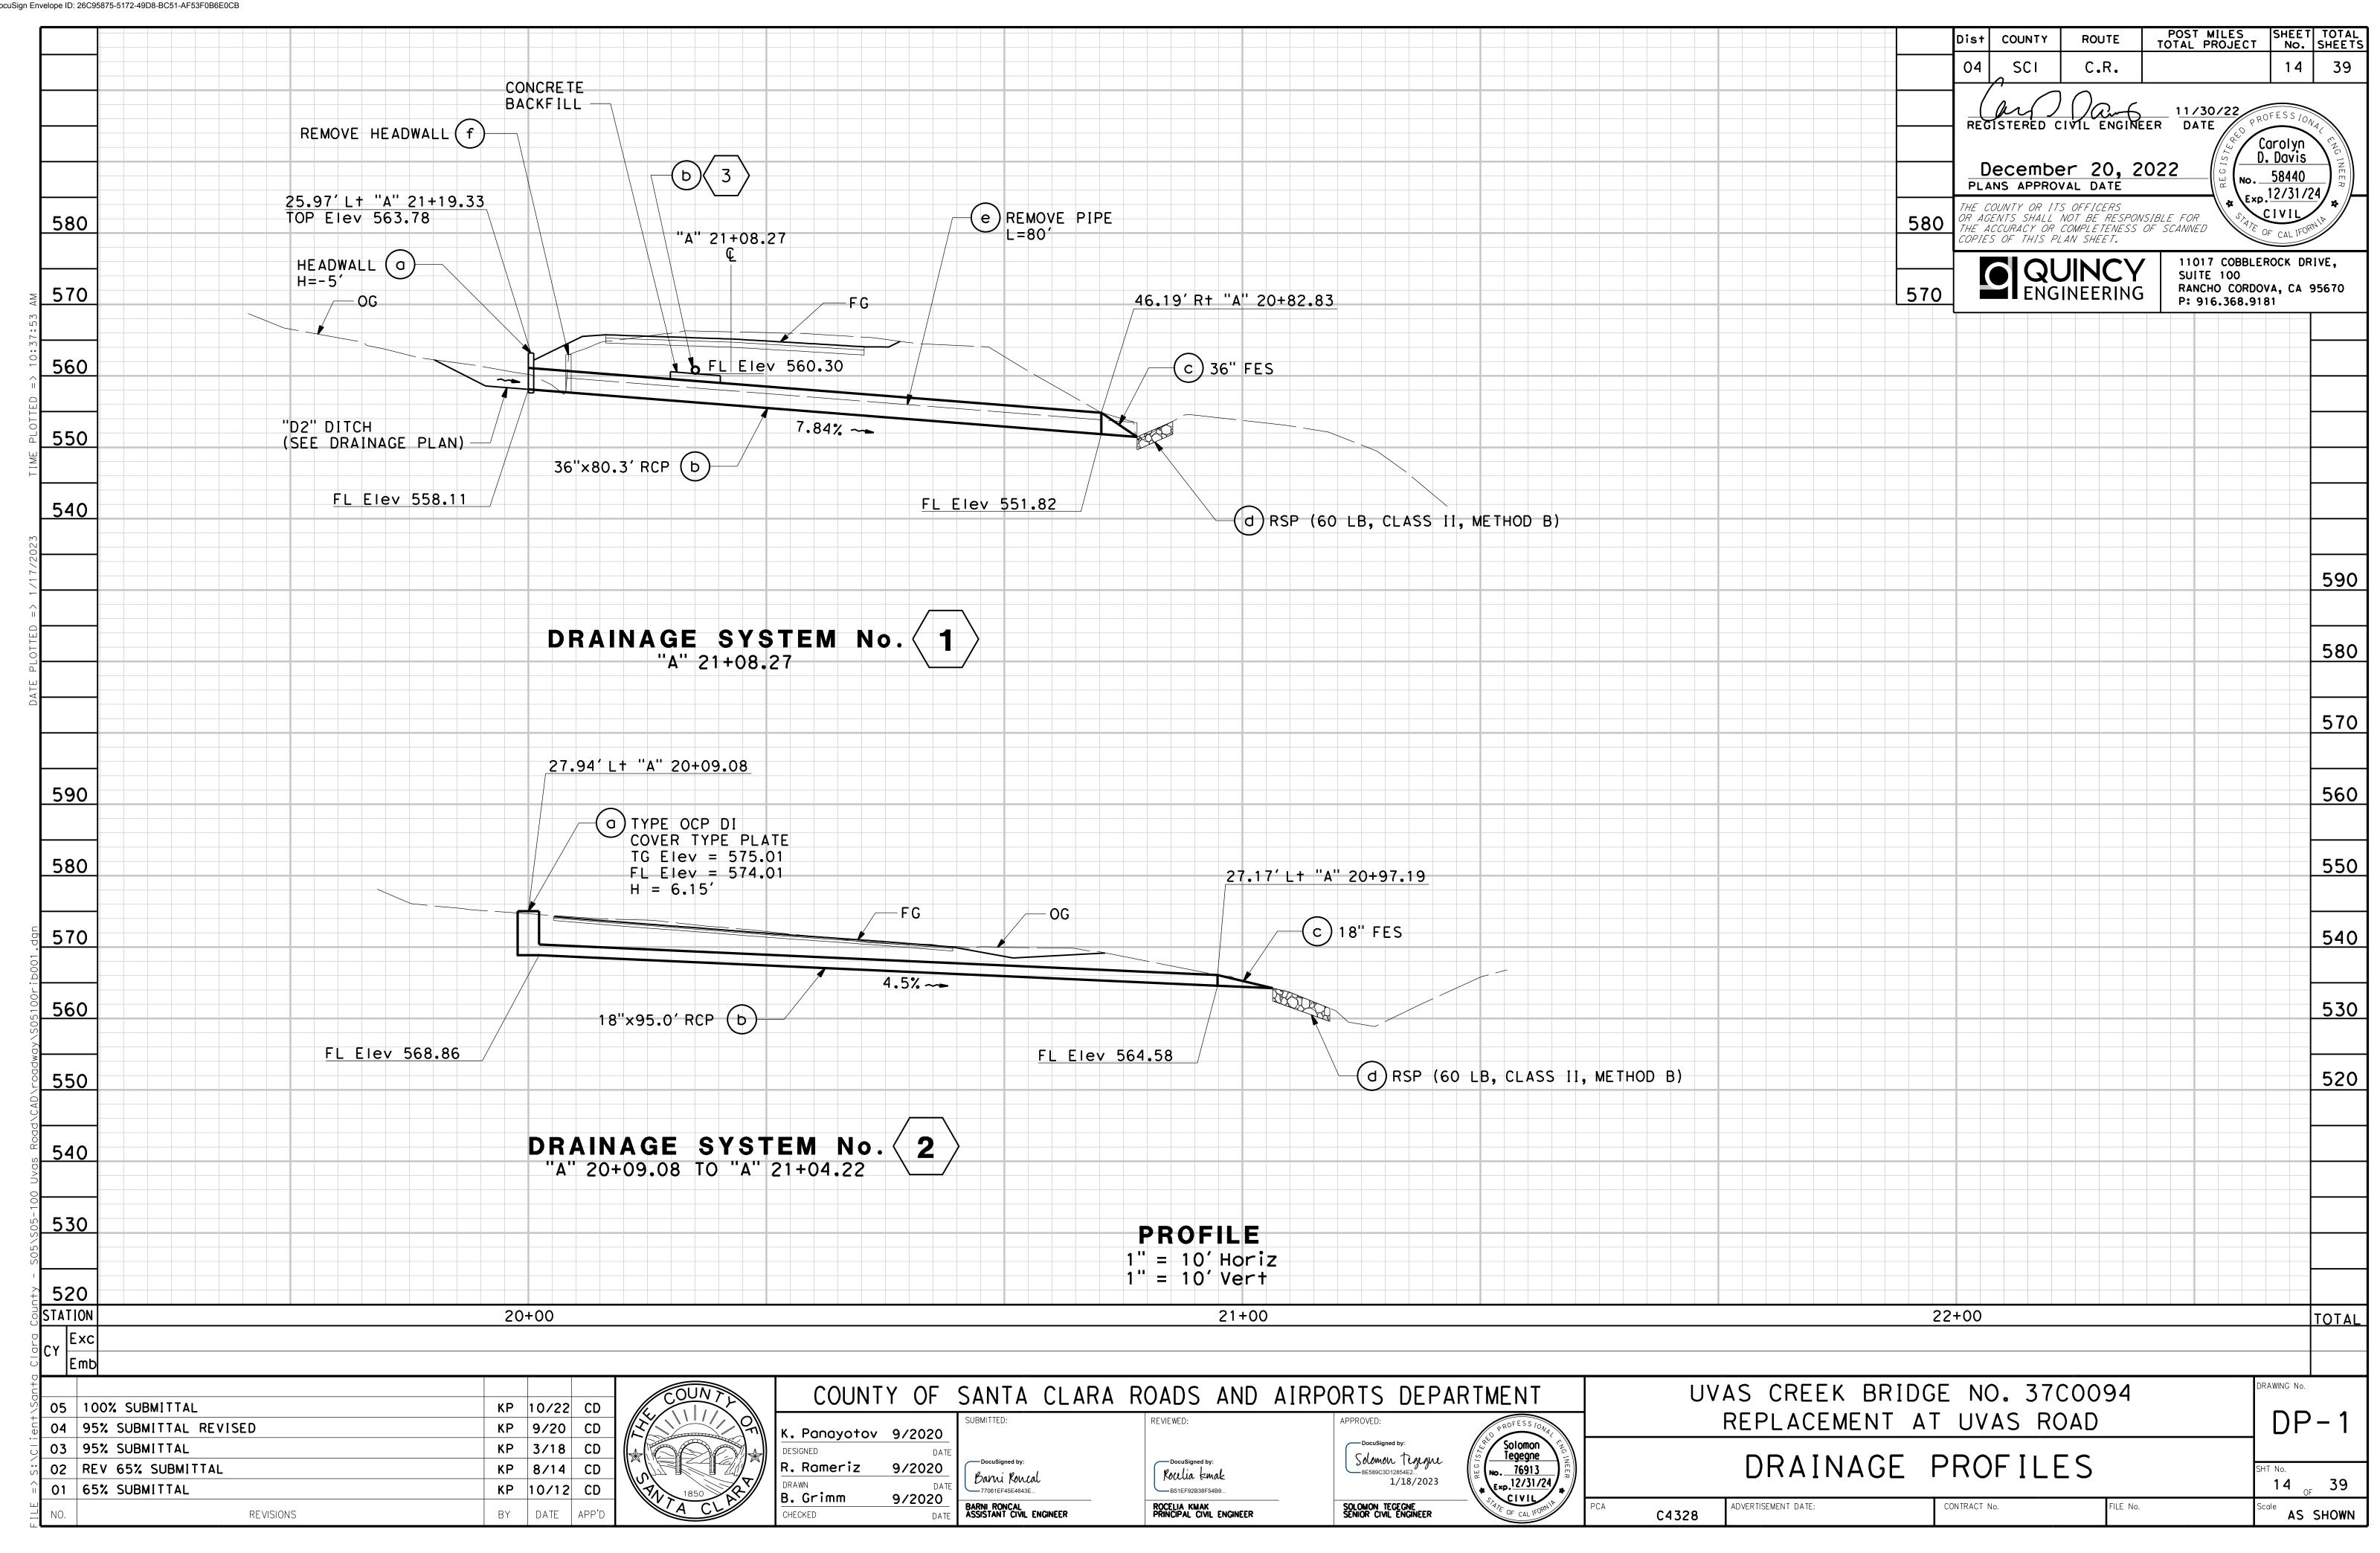


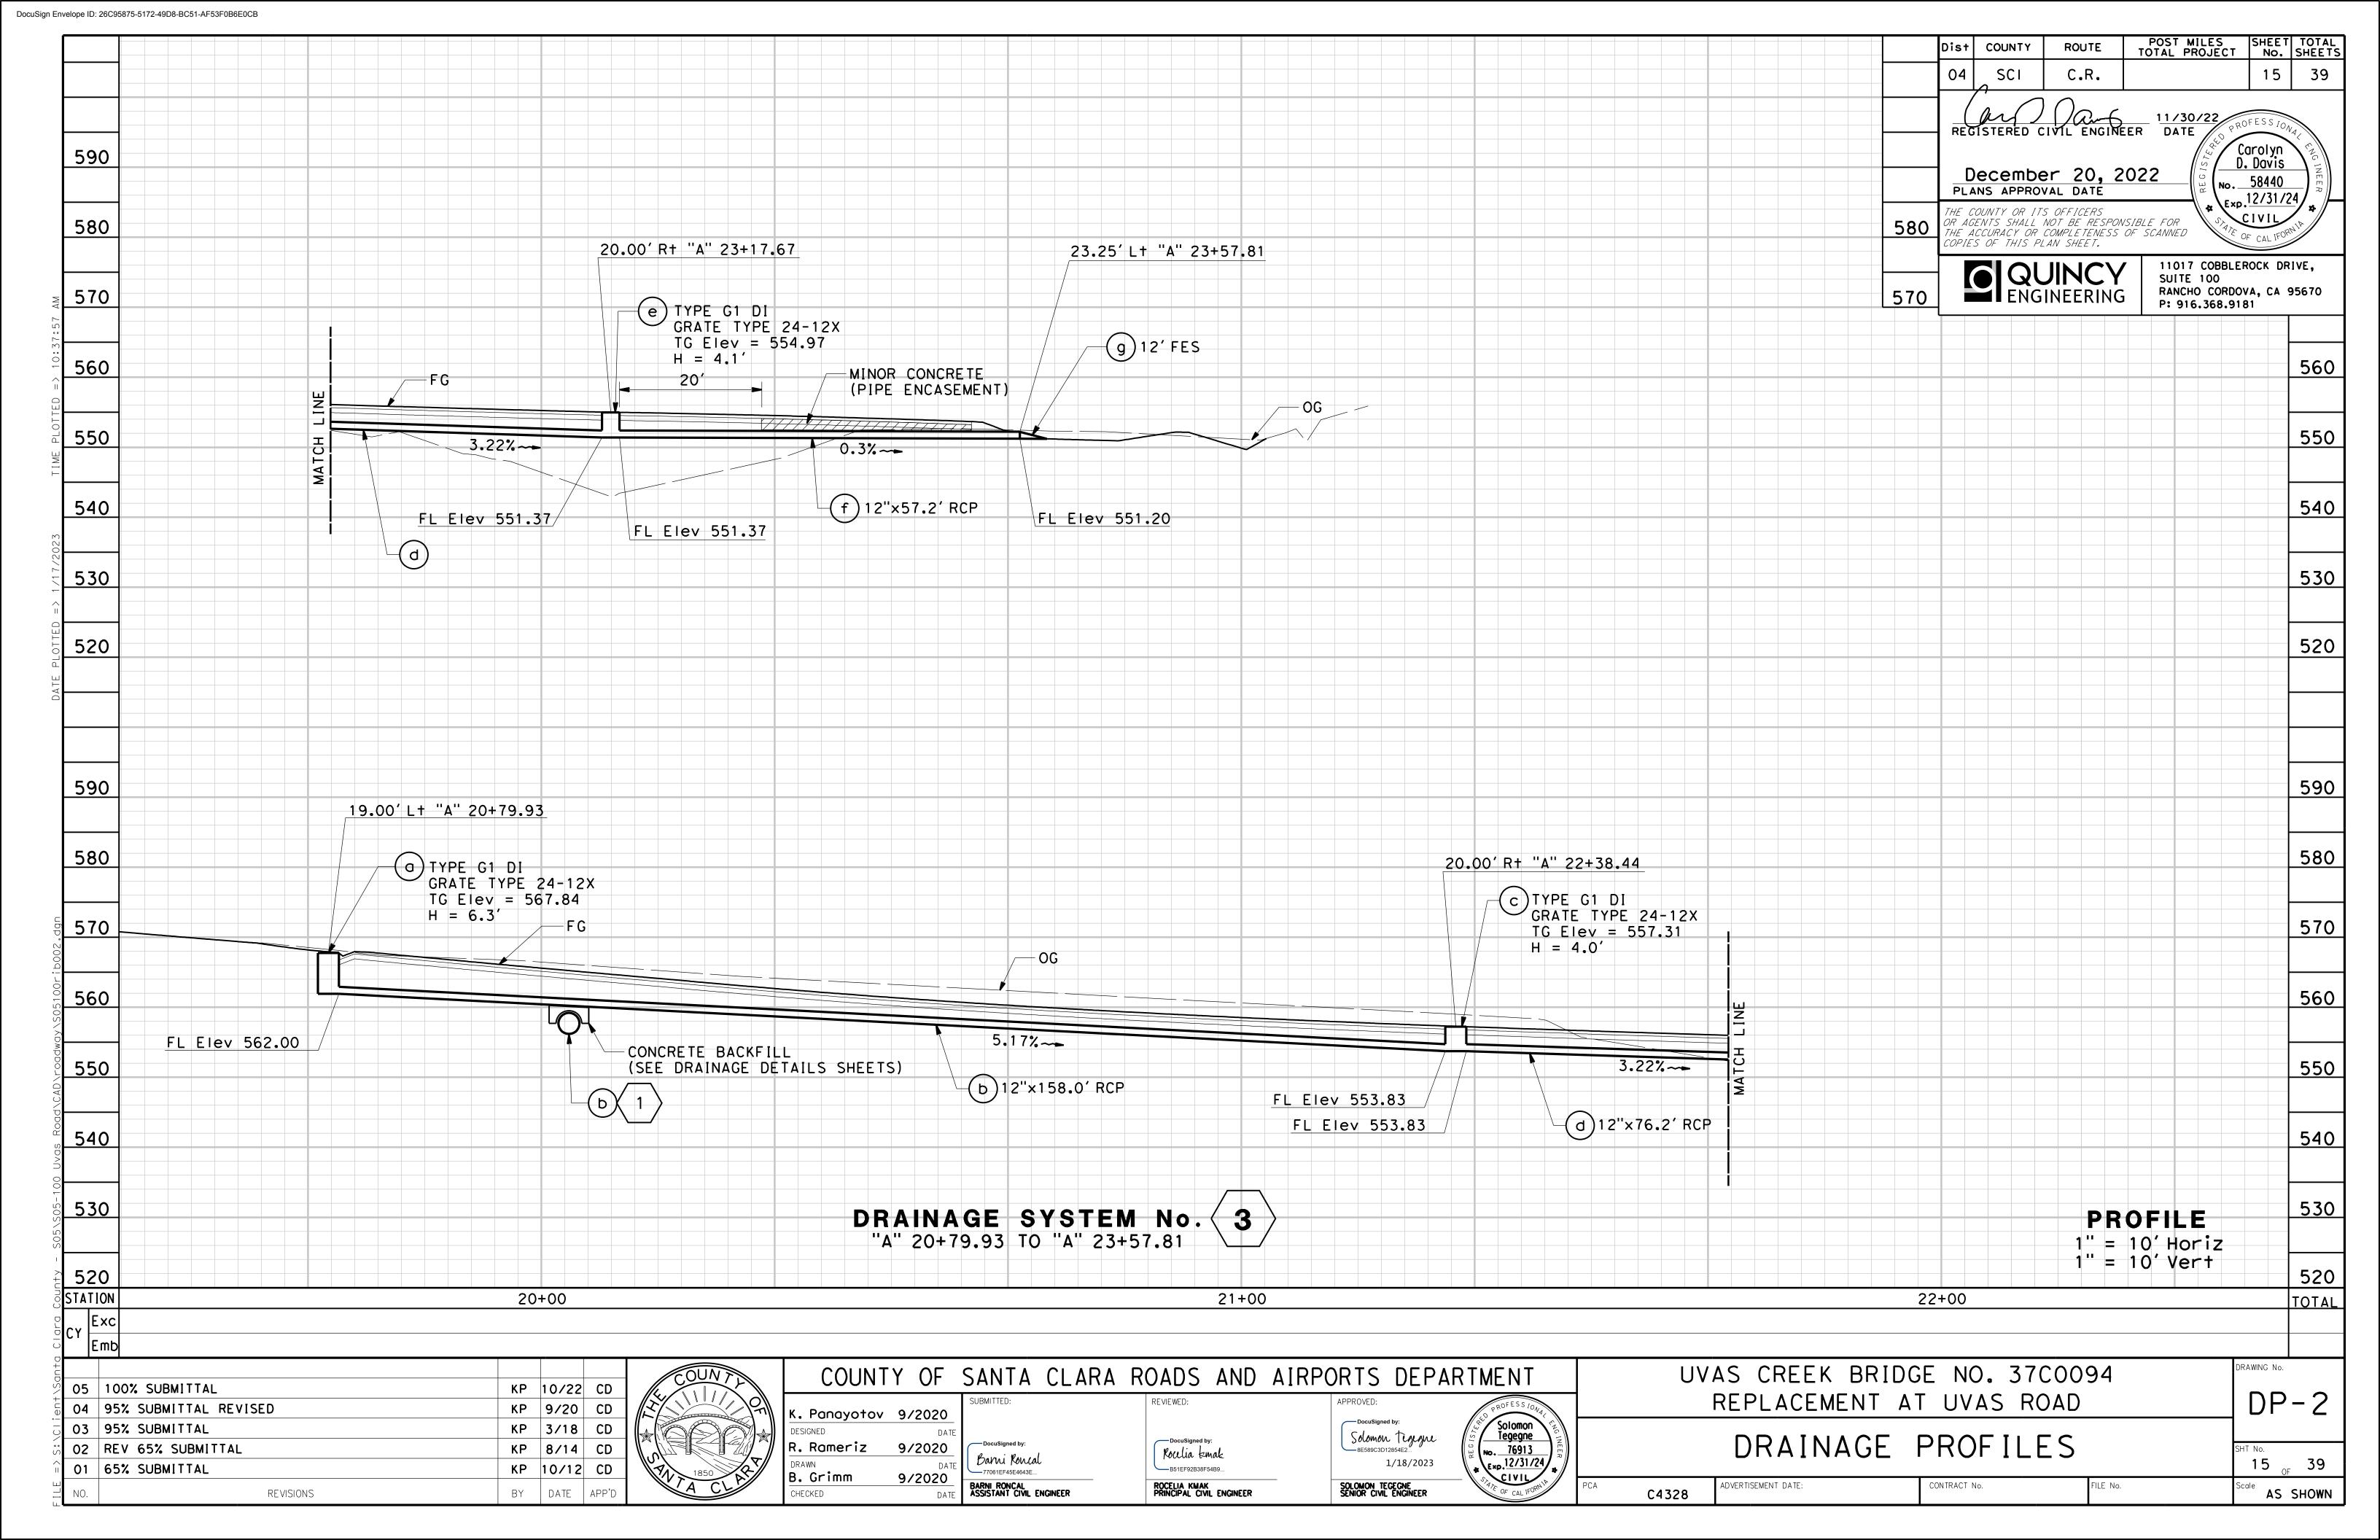

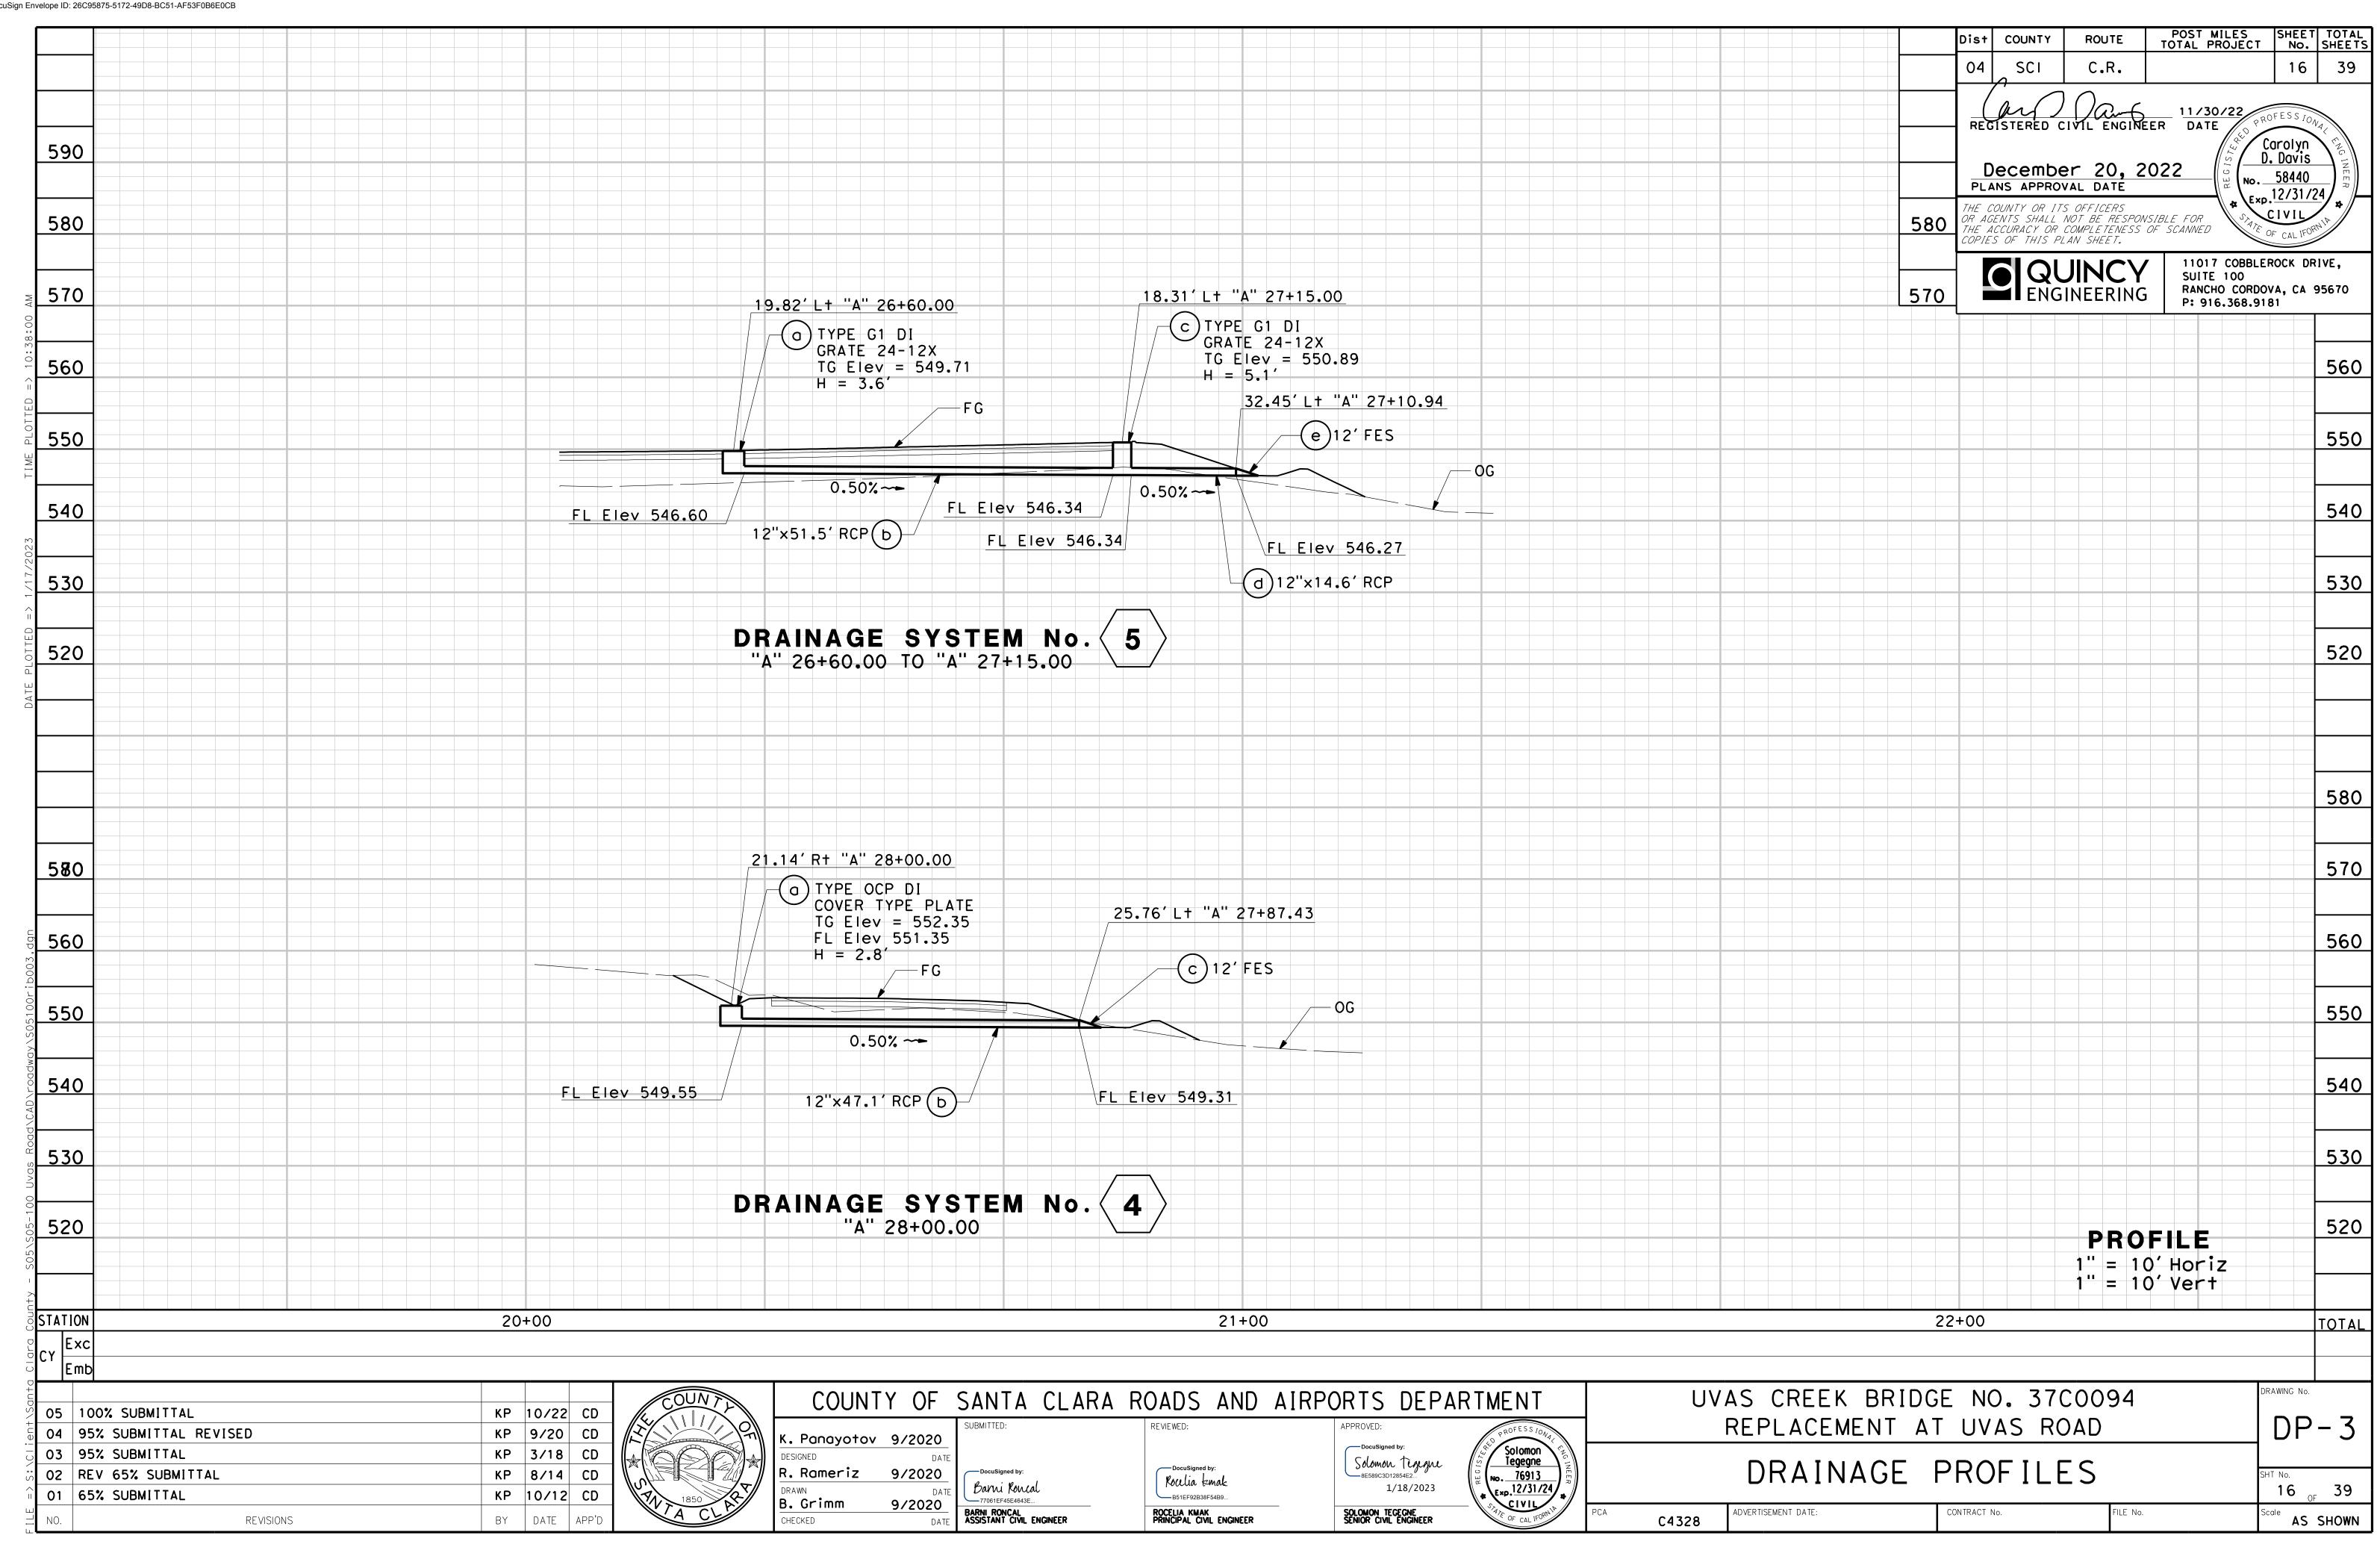

### NOTES:

- 1. FOR RSP CLASS AND DIMENSIONS, SEE TABLE 1.
- 2. FOR FLARED END SECTION DETAILS NOT SHOWN, SEE STANDARD PLAN D94B.
- 3. CUTOFF WALL ONLY PRESENT WITH CONCRETE FES, SEE STANDARD PLAN D94B.

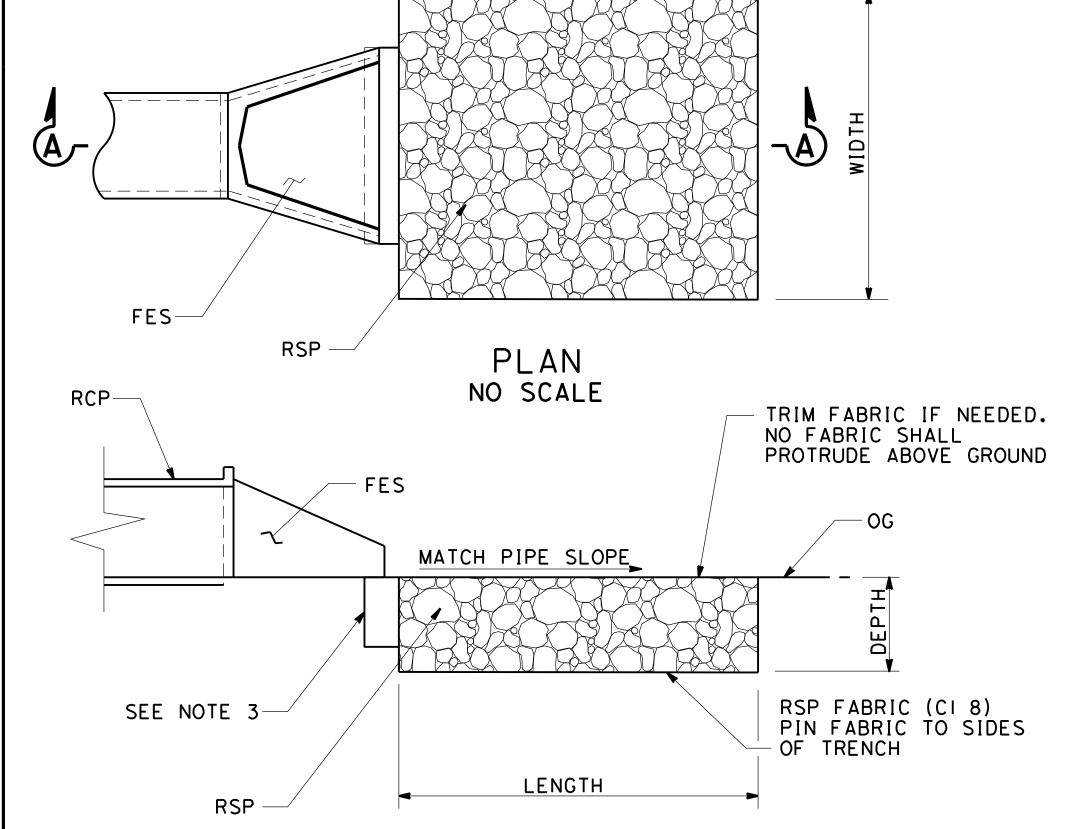

SECTION A-A ROCK SLOPE PROTECTION (RSP) (60 LB, CLASS II, METHOD B)

RELATIVE BORDER SCALE O
IS IN INCHES

REVISIONS

05 100% SUBMITTAL

03 95% SUBMITTAL

01 65% SUBMITTAL

02 REV 65% SUBMITTAL

04 95% SUBMITTAL REVISED

NO SCALE

TABLE 1											
DRAINAGE	RSP	LENGTH	DEPTH	WIDTH							
UNIT	CLASS	FT	FT	FT							
1 d	60 LB, CLASS II, METHOD B	5.0	1.8	6.0							
2d	60 LB, CLASS II, METHOD B	8.0	1.8	4.5							

KP 10/22 CD

KP 9/20 CD

KP 3/18 CD

KP 8/14 CD

KP 10/12 CD

BY DATE APP'D


K. Panayotov 9/2020

R. Rameriz 9/2020

B. Grimm

Barni Roncal

BARNI RONCAL ASSISTANT CIVIL ENGINEER

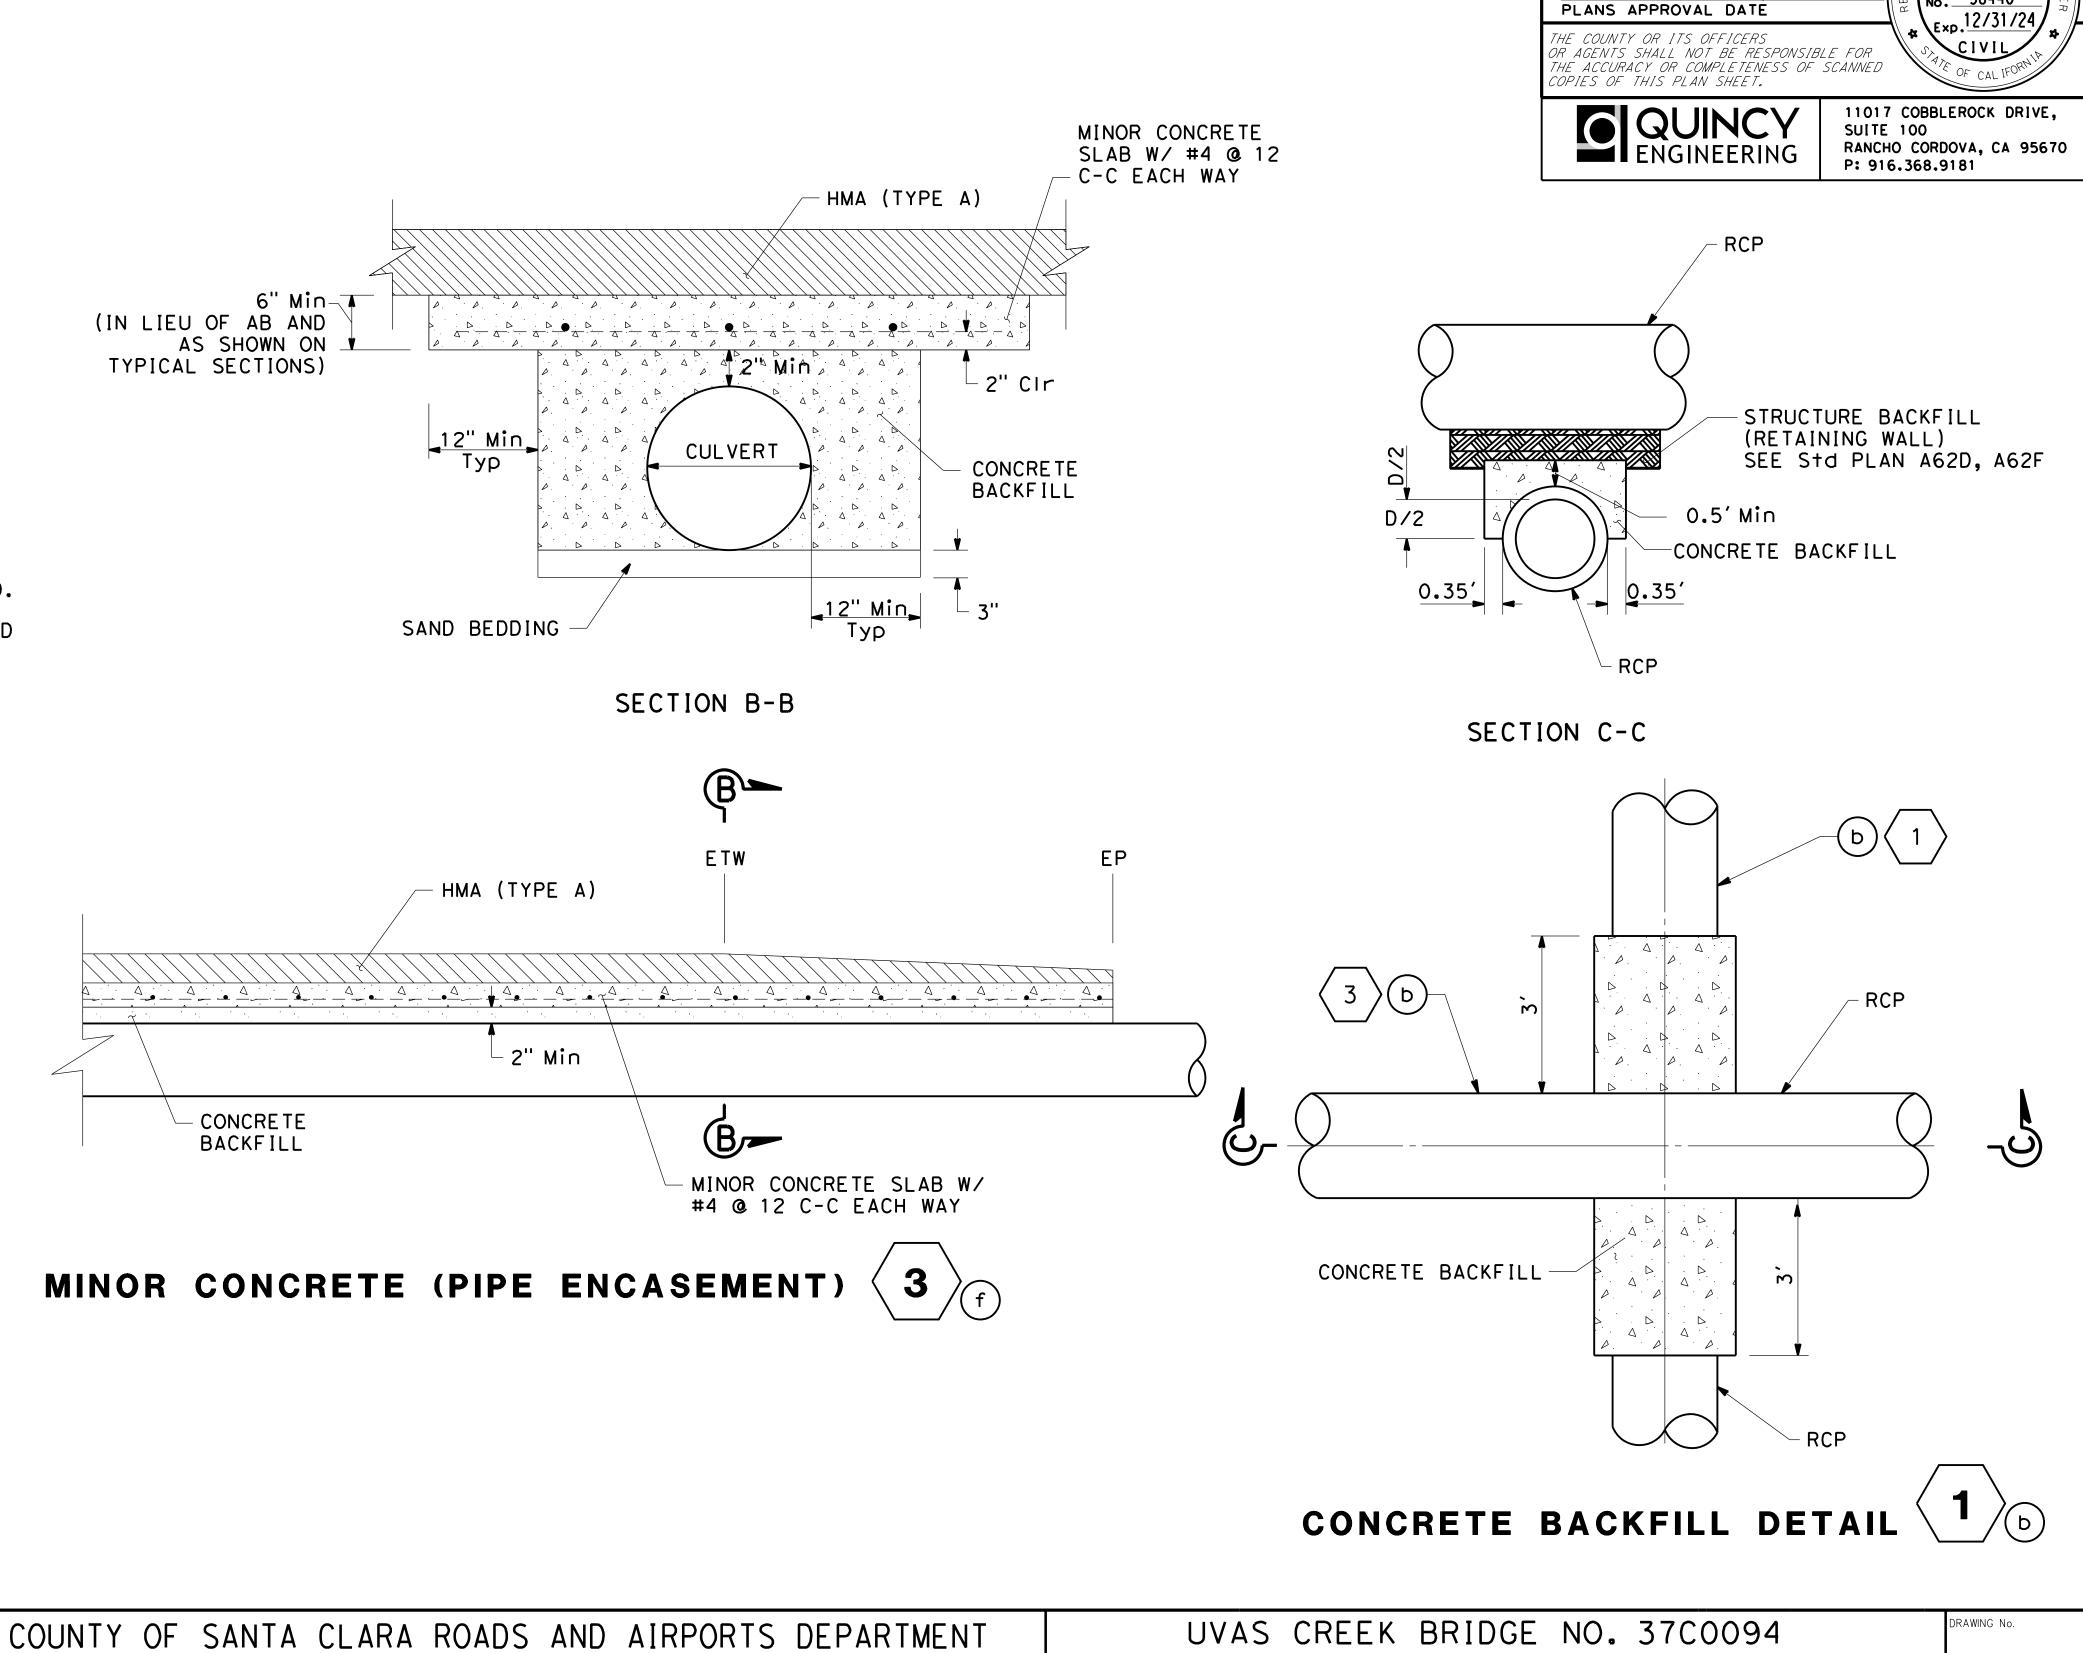

Solomon Tegegne No. 76913

Exp. 12/31/24

Solomon Tigigne
8E589C3D12854E2...

SOLOMON TEGEGNE SENIOR CIVIL ENGINEER

1/18/2023

Rocelia kmak

---B51EF92B38F54B9.

ROCELIA KMAK PRINCIPAL CIVIL ENGINEER

POST MILES SHEET TOTAL TOTAL PROJECT NO. SHEETS

Carolyn D. Davis

DD - 1

17 <sub>OF</sub> 39

AS SHOWN

No. 58440

Dist

04

REPLACEMENT AT UVAS ROAD

DRAINAGE DETAILS

CONTRACT No.

ADVERTISEMENT DATE:

C4328


COUNTY

C.R.

REGISTERED CIVIL ENGINEER DATE


December 20, 2022

PLANS APPROVAL DATE

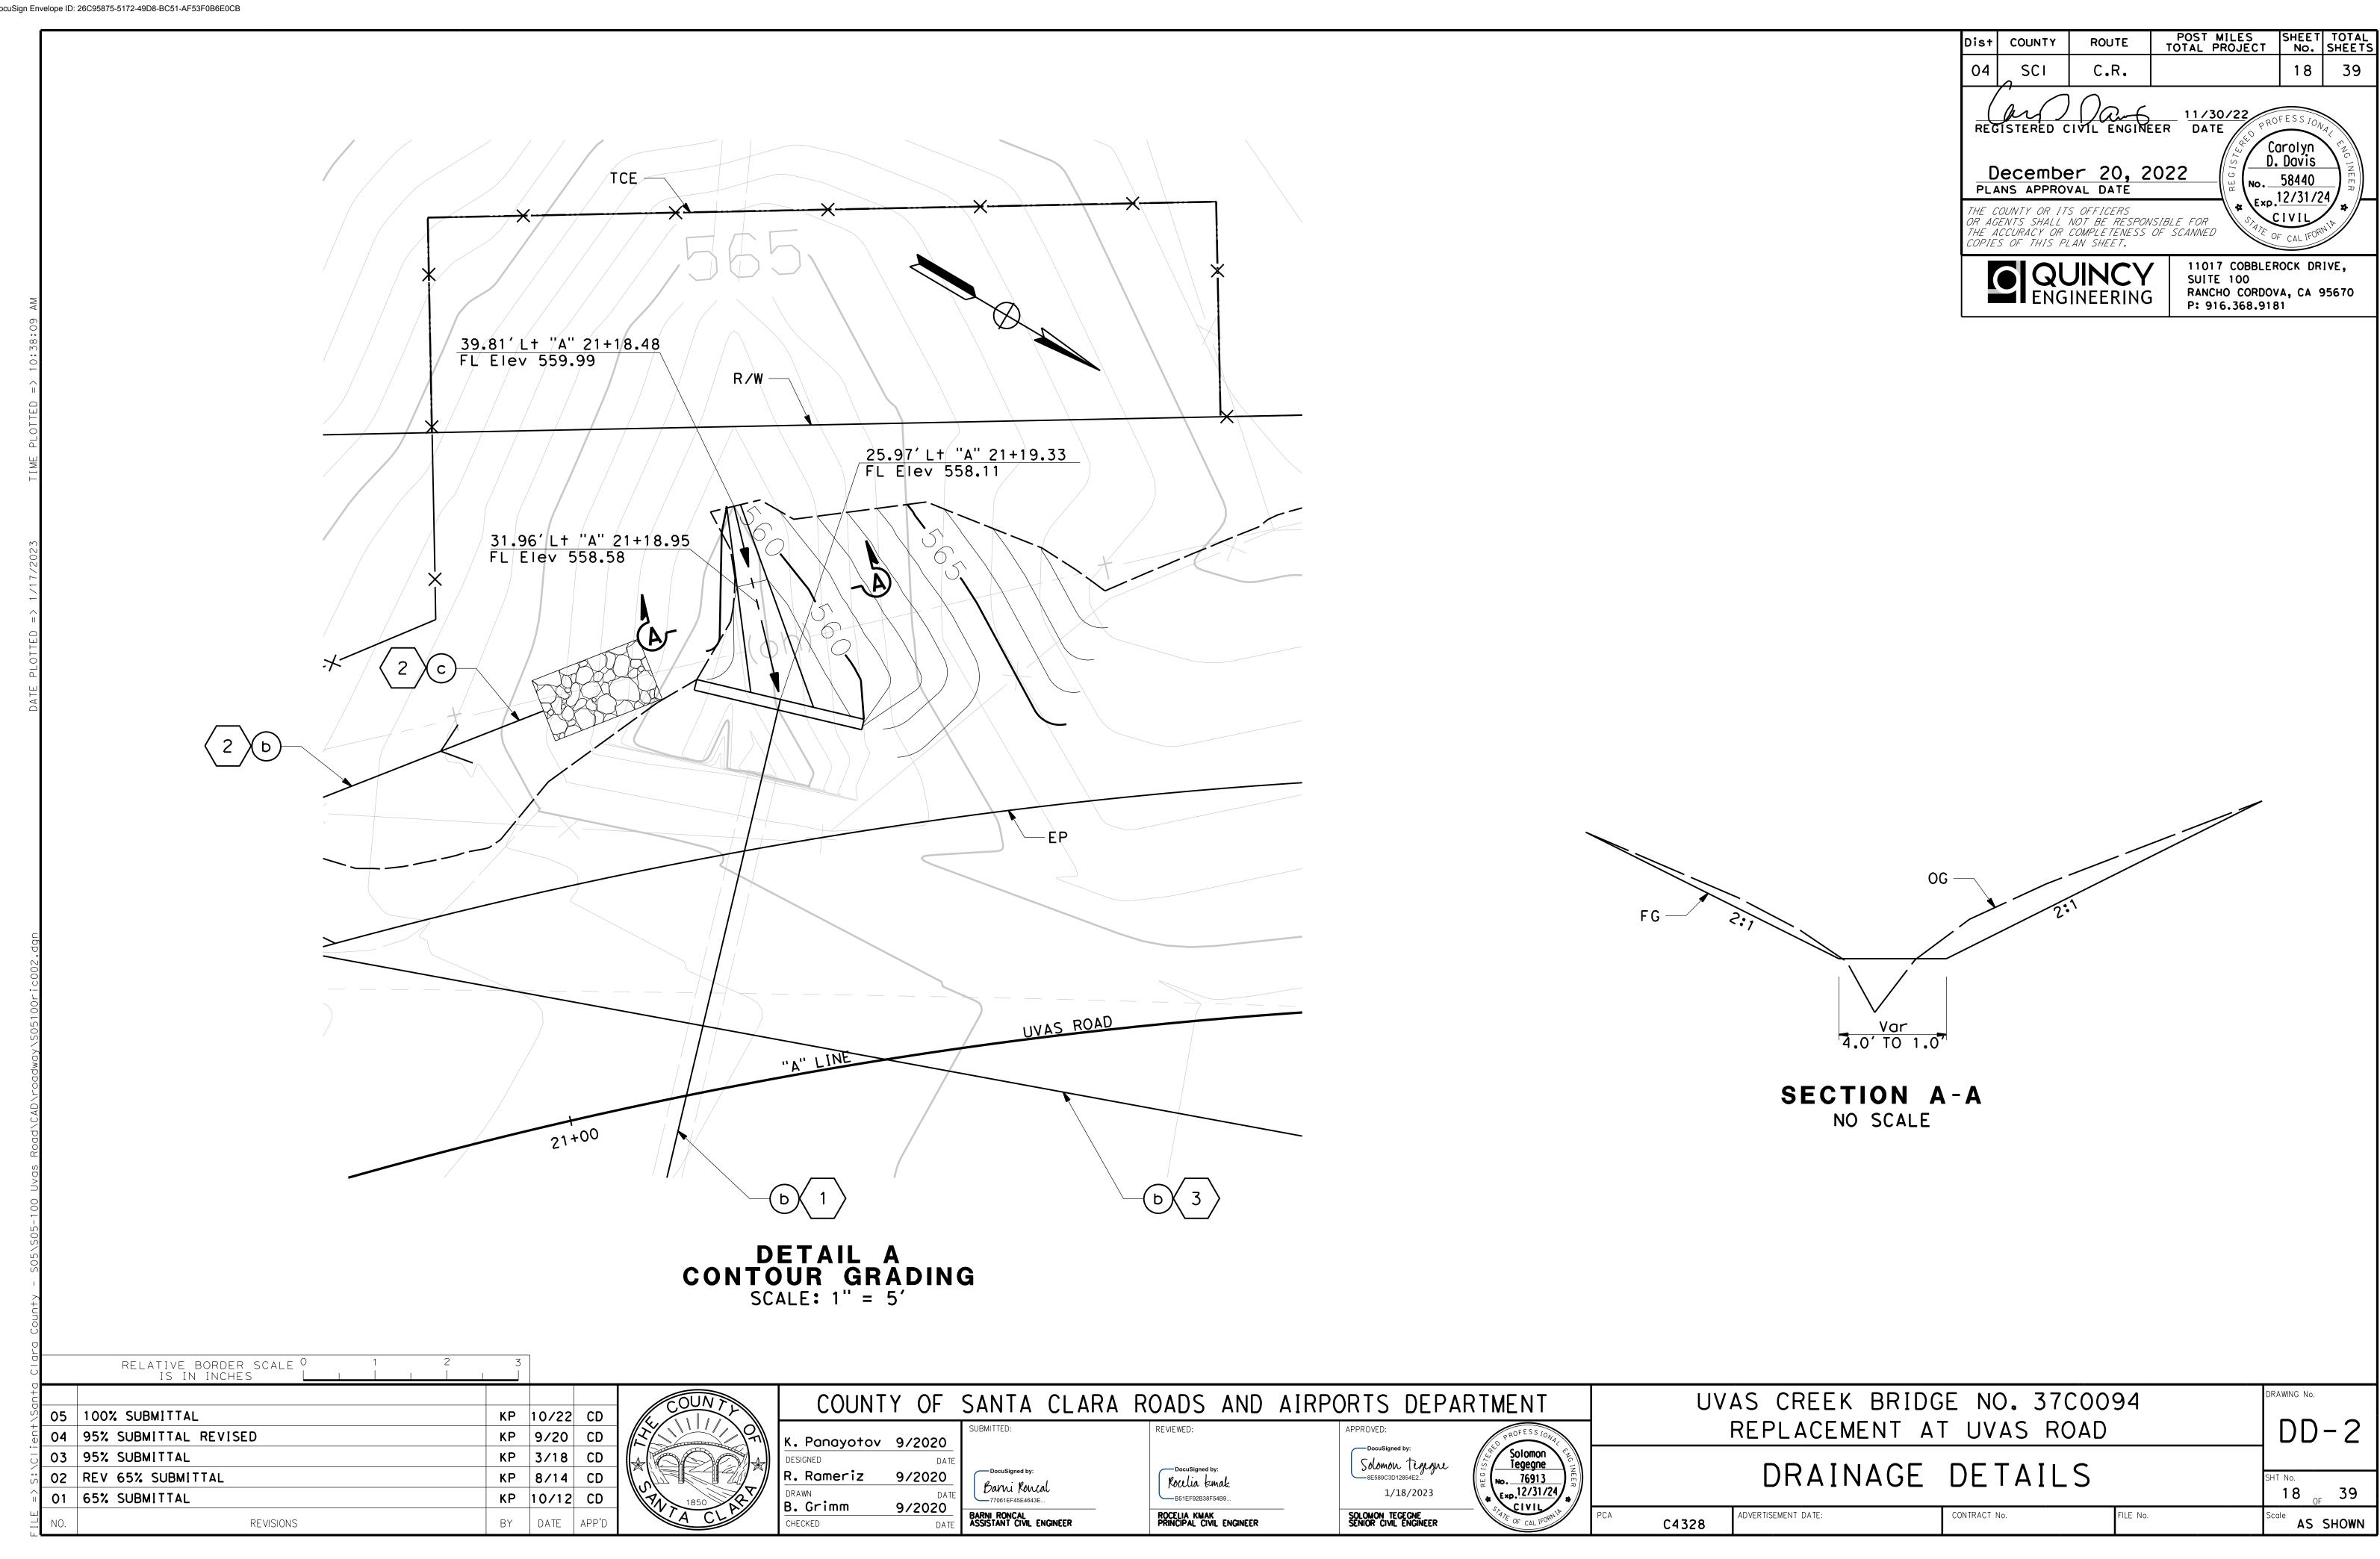

# **BIORETENTION SWALE "B1"** Sta "A" 23+55.00 TO Sta "A" 24+73.11

NO SCALE

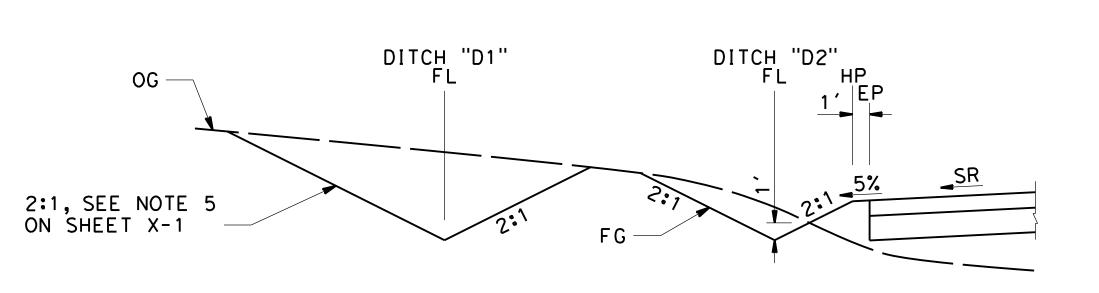

DITCH "D1"
Sta "A" 22+90.00 TO Sta "A" 23+55.00
NO SCALE

# 

# BIORETENTION SWALE "B2" Sta "A" 26+75.00 TO Sta "A" 29+35.09 NO SCALE

### BIORETENTION SWALE B1

STATION	LINE	FL OFFSET	L†/R†	WIDTH	FL Elev	SLOPE (%)			
23+55.00	"A"	28.59′	L†	5.50′	551.41	-4.00			
23+60.00	"A"	25.98′	L+	5.82′	551.21	-4.00			
23+80.00	"A"	29.12′	L+	7.09′	550.40	-4.00			
24+00.00	"A"	30.01′	L+	8.36′	549.60	-4.00			
24+20.00	"A"	30.92′	L+	9.63'	548.80	-4.00			
24+40.00	"A"	31.75′	L+	10.90′	548.01	-4.00			
24+60.00	"A"	32.55′	L+	12.17′	547.23	-4.00			
24+73.11	"A"	33.48′	L+	13.00′	546.72	-4.00			

DITCH "D1"

DITCH DI						
STATION	LINE	FL OFFSET	L+/R+	FL Elev	SLOPE (%)	
22+90.00	"A"	23.31′	L†	555.10		
23+00.00	"A"	24.55′	L+	554.54	-5.60	
23+20.00	"A"	27.02′	L†	553.43	-5.55	
23+30.00	"A"	28.26′	L+	552.88	-5.50	
23+40.00	"A"	31.89′	L+	552.29	-5.90	
23+55.00	"A"	37.34'	L†	551.41	-5.87	
23+60.00	"A"	39.86′	L†	554.43	-9.60	
23+80.00	"A"	46.15′	L†	549.68	-5.85	
24+00.00	"A"	49.21′	L†	548.43	-6.55	
24+20.00	"A"	52.20′	L†	547.22	-6.90	
24+40.00	"A"	54.60′	L†	546.28	-5.75	
24+60.00	"A"	56.78′	L†	545.45	-4.10	
24+73.11	"A"	58.61′	L†	544.90	-3.51	

DITCH "D2"

	51.0 52						
STATION	LINE	FL OFFSET	L+/R+	FL Elev	SLOPE (%)		
22+90.00	"A"	19.16′	L†	555.19			
23+00.00	"A"	19.36′	L†	554.75	-4.40		
23+20.00	"A"	19.77′	L†	553.90	-4.25		
23+30.00	"A"	19.97′	L+	553.50	-4.00		
23+40.00	"A"	21.93′	L+	552.72	-7.80		
23+45.00	"A"	22.37′	L†	552.36	-7.20		
23+55.00	"A"	28.59′	L†	551.41	-9.50		
_				_			

### BIORETENTION SWALE B2

STATION	LINE	FL OFFSET	L†/R†	WIDTH	FL Elev	SLOPE (%)
26+75.00	"A"	38.36′	L+	2.00′	544.88	4.00
26+80.00	"A"	37.99′	L†	2.08′	545.08	4.00
27+00.00	"A"	36.33′	L+	2.39′	545.88	4.00
27+20.00	"A"	34.39′	L+	2.69′	546.68	4.00
27+40.00	"A"	32.20′	L+	3.00′	547.48	4.00
27+60.00	"A"	30.71′	L+	3.31′	548.28	4.00
27+80.00	"A"	29.23′	L†	3 <b>.</b> 61′	549.08	4.00
28+00.00	"A"	27.91′	L+	3.92′	549.88	4.00
28+20.00	"A"	26.75′	L+	4.23′	550.68	4.00
28+40.00	"A"	25.74′	L†	4.54′	551.48	4.00
28+60.00	"A"	24.88′	L+	4.85′	552.28	4.00
28+80.00	"A"	24.17′	L†	5 <b>.</b> 15′	553.08	4.00
29+00.00	"A"	23.61′	L†	5.46′	553.88	4.00
29+20.00	"A"	23.20′	L†	5.77′	554.68	4.00
29+35.09	''A''	23.13′	L†	6.00′	555.28	4.00

	RELATIVE BORDER SCALE <sup>0</sup> 1 2 IS IN INCHES L 1 1 1 1	3		
05	100% SUBMITTAL	KP	10/22	CD
04	95% SUBMITTAL REVISED	KP	9/20	CD
03	95% SUBMITTAL	KP	3/18	CD
02	02 REV 65% SUBMITTAL			CD
01	65% SUBMITTAL	KP	10/12	CD
NO.	REVISIONS	BY	DATE	APP'D



COUNTY OF	SANTA	CLARA	ROADS	AND	AIRPO	RTS	DEPARTMENT
V December 0.40000	SUBMITTED:		REVIEWED:		A	APPROVED:	PROFESSION

K. Panayotov 9/2020

DESIGNED DATE

R. Rameriz 9/2020

DRAWN DATE

B. Grimm 9/2020

CHECKED DATE

DATE
O
DOCUSigned by:

BAYNI RONCAL
ASSISTANT CIVIL ENGINEER

Pocusigned by:

Kowia Emak

B51EF92B38F54B9...

ROCELIA KMAK
PRINCIPAL CIVIL ENGINEER

APPROVED:

Solomon Tegegne

1/18/2023

SOLOMON TEGEGNE
SENIOR CIVIL ENGINEER

SOLOMON TEGEGNE
SENIOR CIVIL ENGINEER

UVAS CREEK BRIDGE NO. 37C0094 REPLACEMENT AT UVAS ROAD

DRAINAGE DETAILS

DD-3

SHT No.
19 OF 39

DRAWING No.

POST MILES SHEET TOTAL TOTAL PROJECT No. SHEETS

11017 COBBLEROCK DRIVE, SUITE 100 RANCHO CORDOVA, CA 95670 P: 916.368.9181

REGISTERED CIVIL ENGINEER DATE

December 20, 2022

THE COUNTY OR ITS OFFICERS OR AGENTS SHALL NOT BE RESPONSIBLE FOR THE ACCURACY OR COMPLETENESS OF SCANNED COPIES OF THIS PLAN SHEET.

PLANS APPROVAL DATE

C4328

ADVERTISEMENT DATE:


CONTRACT No.

FILE No.


Scale AS SHOWN


BY DATE

REVISIONS

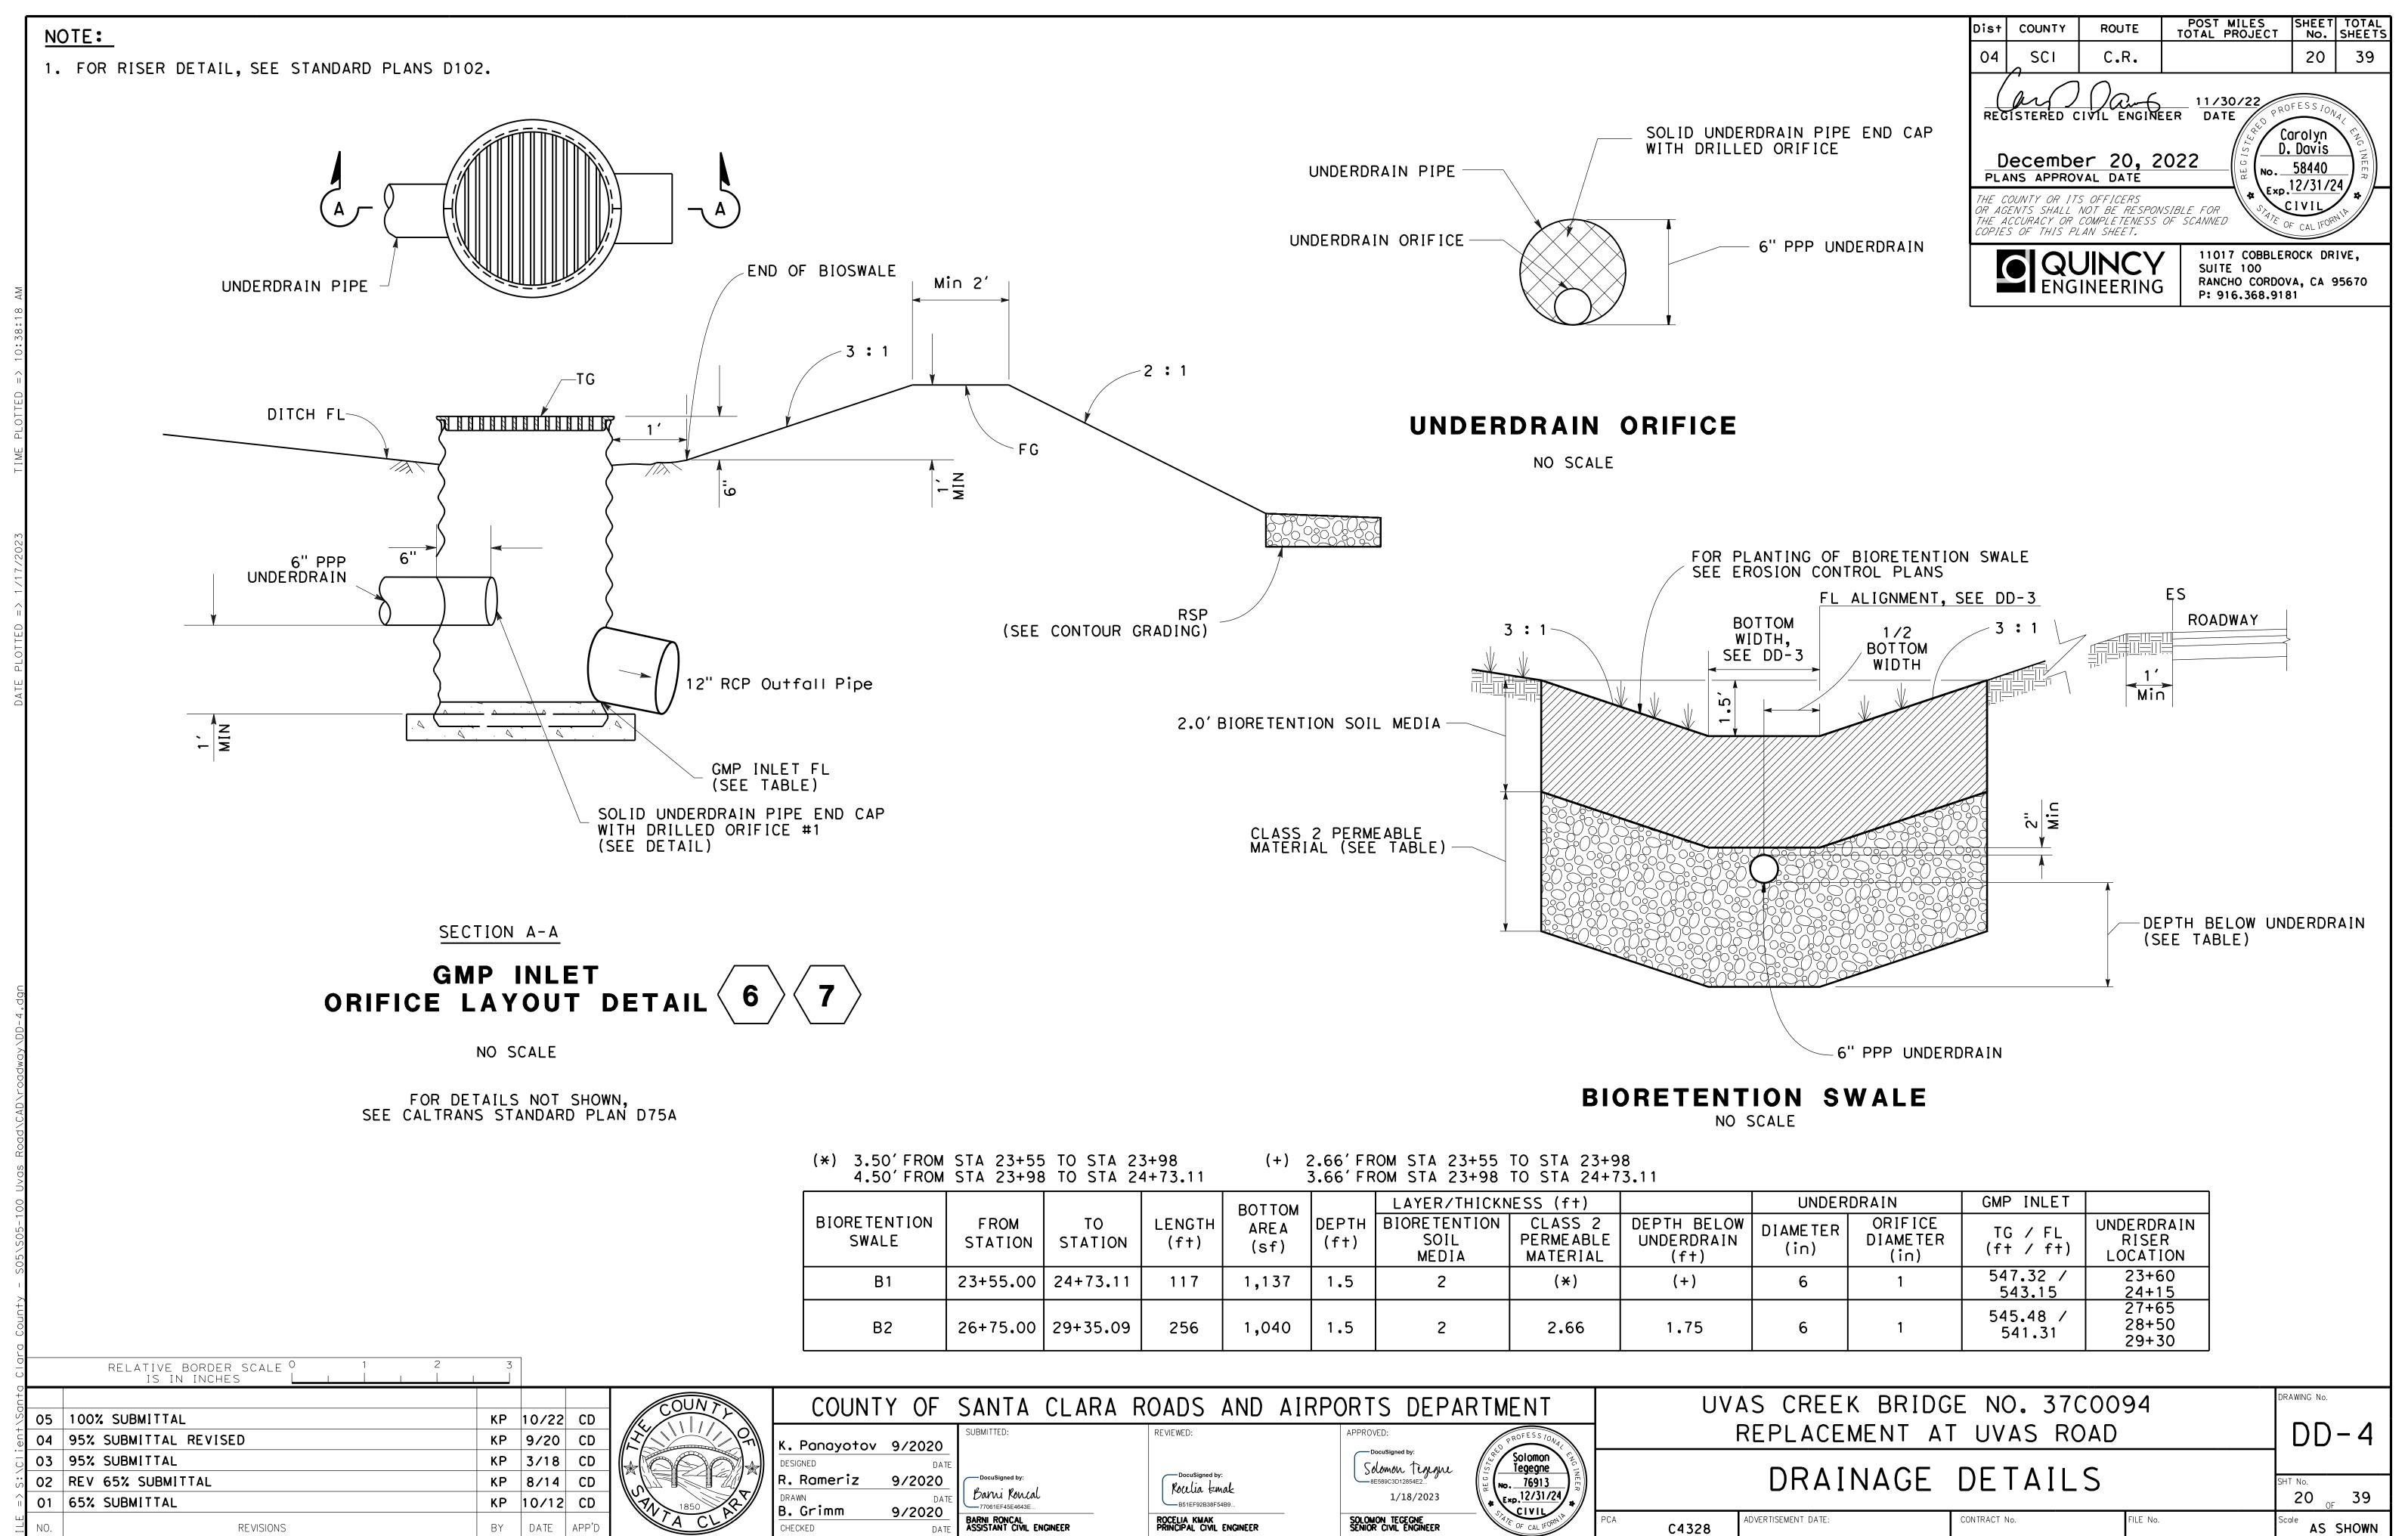


C4328

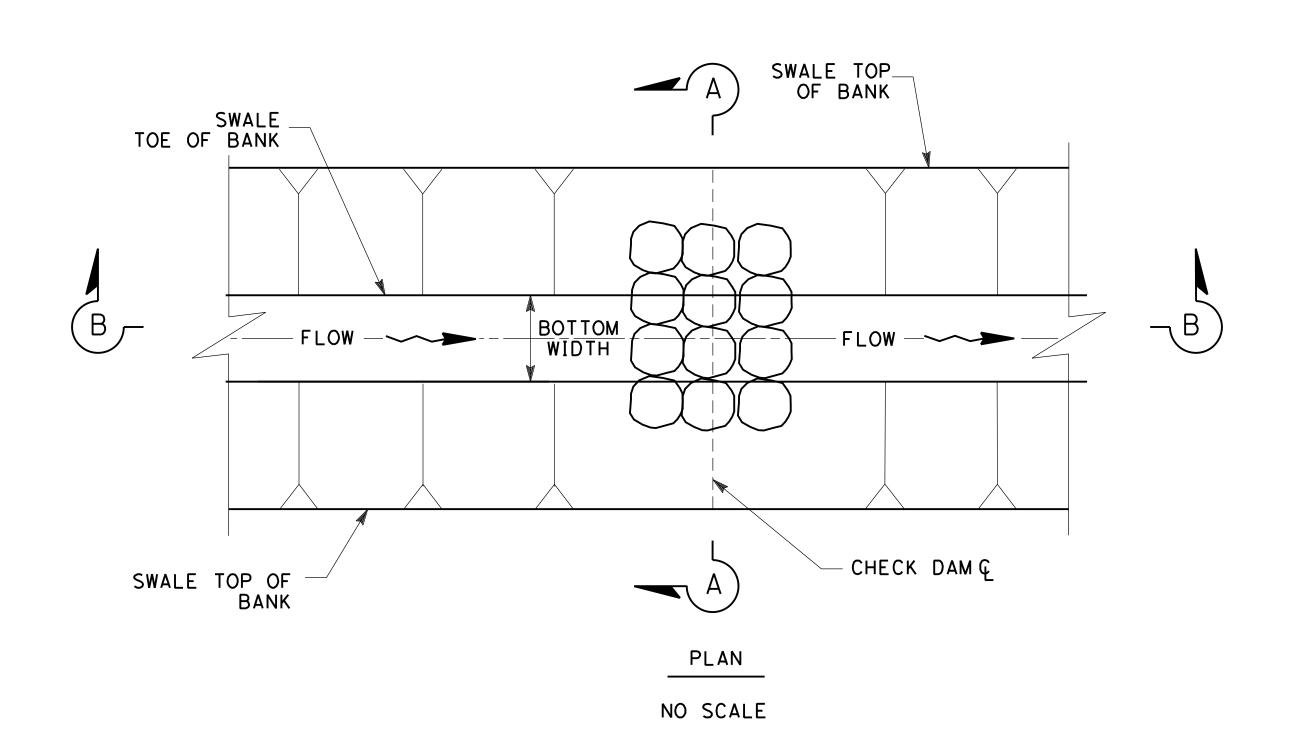

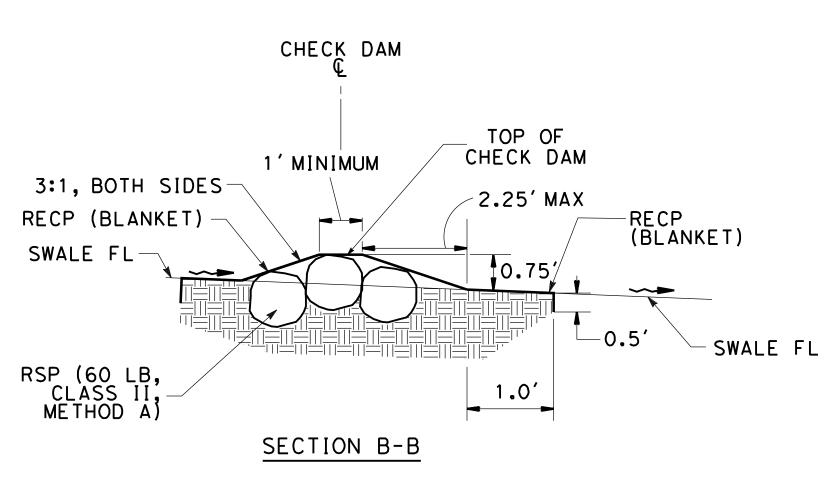

# ROCK CHECK DAM

NO SCALE

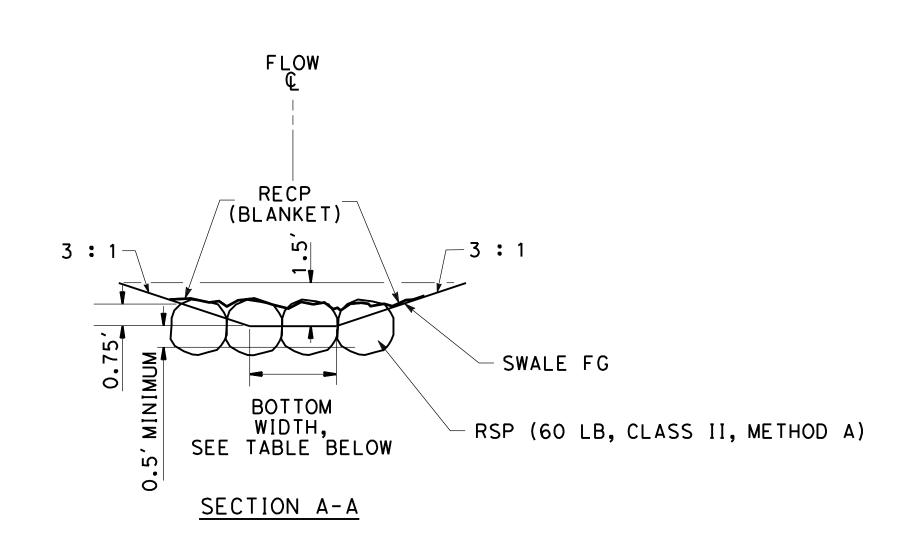

### ROCK CHECK DAM

NO SCALE

NOTES:
1. RECP (BLANKET) ALL AROUND. (USE SHEET ECL-1 FOR DETAILS)
2. KEY TRENCH

Dist

04

COUNTY

SCI

REGISTERED CIVIL ENGINEER DATE

December 20, 2022

QUINCY ENGINEERING


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PLANS APPROVAL DATÉ

## ROCK CHECK DAM LOCATIONS

BIORETENTION SWALE	ROCK CHECK DAM © STATION	BOTTOM WIDTH (f+)
B1	23+80.00	7.09
B1	24+00.00	8.36
B1	24+20.00	9.63
B1	24+40.00	10.90
B1	24+60.00	12.17
B2	27+00.00	2.39
B2	27+20.00	2.69
B2	27+40.00	3.00
B2	27+60.00	3.31
B2	27+80.00	3.61
B2	28+00.00	3.92
B2	28+20.00	4.23
B2	28+40.00	4.54
B2	28+60.00	4.85
B2	28+80.00	5.15
B2	29+00.00	5.46
B2	29+20.00	5.77

ı Cla		RELATIVE BORDER SCALE <sup>0</sup> 1 2 IS IN INCHES LLL LLL	3		
ent\Santa					
-\Sc	05	100% SUBMITTAL	KP	10/22	CD
ent	04	95% SUBMITTAL REVISED	KP	9/20	CD
   	03	95% SUBMITTAL	KP	3/18	CD
S	02	REV 65% SUBMITTAL	KP	8/14	CD
^ II	01	65% SUBMITTAL	KP	10/12	CD
ILE	NO.	REVISIONS	BY	DATE	APP'D

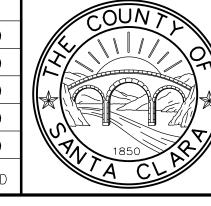


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2	к.	Panayo <sup>.</sup>
	DESI	GNED
	R.	Rameria
	DRA <b>B.</b>	wn Grimm

otov 9/2020 iz 9/2020 Barni Roncal 9/2020

BARNI RONCAL ASSISTANT CIVIL ENGINEER

Rocelia kmak ---B51EF92B38F54B9. ROCELIA KMAK PRINCIPAL CIVIL ENGINEER

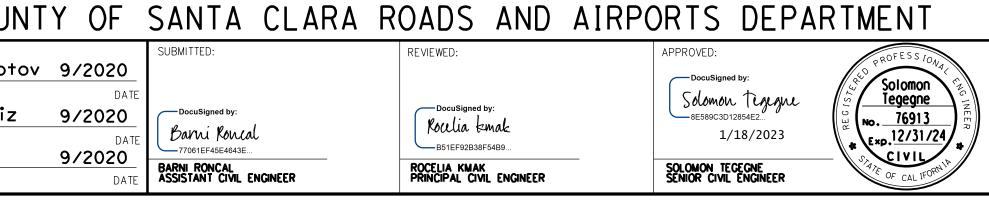

UVAS CREEK BRIDGE NO. 37C0094 REPLACEMENT AT UVAS ROAD

DRAINAGE DETAILS

CONTRACT No.

ADVERTISEMENT DATE:

C4328

DD-5

DRAWING No.

21 <sub>OF</sub> 39 AS SHOWN

POST MILES SHEET TOTAL TOTAL PROJECT No. SHEETS

21

Carolyn D. Davis

No. 58440 Exp. 12/31/24/

11017 COBBLEROCK DRIVE, SUITE 100 RANCHO CORDOVA, CA 95670 P: 916.368.9181

DocuSign Envelope ID: 26C95875-5172-49D8-BC51-AF53F0B6E0CB REGISTERED CIVIL ENGINEER 11/30/22 DATE Carolyn D. Davis December 20, 2022 No. 58440 Exp. 12/31/24 PLANS APPROVAL DATE THE COUNTY OR ITS OFFICERS
OR AGENTS SHALL NOT BE RESPONSIBLE FOR
THE ACCURACY OR COMPLETENESS OF SCANNED
COPIES OF THIS PLAN SHEET. **QUINCY** ENGINEERING 11017 COBBLEROCK DRIVE, SUITE 100 RANCHO CORDOVA, CA 95670 P: 916.368.9181 DRAINAGE ITEMS BL " CORRUGATED EEL PIPE INLE' .079" THICK) ⋖ 36" REINFORCED CONCRETE PIPE PERME CL CL 12" CONCRET FLARED END SECTION SECTION 36" CONCRET FLARED END SECTION SECTION S STRUCTURAL CONCRETE, HEADWALL STRUCTURAL CONCRETE, DRAINAGE IN (60 LB) METHOD 12" REINFO 18" REINF CONCRETE DESCRIPTION STATION 6" PERFO PLASTIC UNDERDRA BIORETER SOIL ME  $\sim$   $\leq$ REMOVE SMisc STEE  $\mathsf{N}$  $\triangleleft$   $\vdash$ 노<mark>무</mark> 36 ST (0, RS (8 CL SQYD "A' 21+19.33 HEADWALL H=4'-8" L=14' 6.2 36" X 80.0' RCP, CONCRETE BACKFILL 80.0 36" CONCRETE FLARED END SECTION "A" 20+82.83 R+ 9.2 RSP (60 Ib, CLASS II, METHOD B) 2.0 REMOVE PIPE 36" REMOVE HEADWALL "A" 20+09.08 OCP DI GRATE TYPE PLATE 112 4.7 6.70 18" X 95.0' RCP 95.0 "A" 20+97**.**19 18" CONCRETE FLARED END SECTION L† RSP (60 1b, CLASS II, METHOD B) 10.4 G1 DI GRATE TYPE 24-12X "A" 20+79.93 239 6.3 5.8 1.7 L+ 12" X 158.0' RCP 158.0 2.5 "A" 22+38.44 G1 DI GRATE TYPE 24-12X 239 4.0 1.2 R+ 12" X 76.2' RCP 76.2 "A" 23+17.67 1.2 G1 DI GRATE TYPE 24-12X 239 2.6 R† 4.1 57.2 12" X 57.2' RCP, MINOR CONCR. (PIPE ENCASEMENT) "A" 23+57.81 12" CONCRETE FLARED END SECTION L+ "A" 28+00.00 2.8 3.30 OCP DI GRATE TYPE PLATE 112 R† 47.1 12" X 47.1' RCP "A" 27+87.43 L+ 12" CONCRETE FLARED END SECTION 3.6 "A" 26+60.00 G1 DI GRATE TYPE 24-12X 5 L+ 239 2.1 1.1 12" X 51.5' RCP 51.5 "A" 27+15.00 G1 DI GRATE TYPE 24-12X L+ 239 5.1 3.6 1.4 12" X 14.6' RCP 14.6 12" CONCRETE FLARED END SECTION "A" 27+10**.**94 L† "A" 24+70.55 L† 236 4.2 4.7 TYPE GMP DI, GRATE TYPE 36R 6 24.8 12" X 24.8' RCP "A" 26+77.56 236 4.2 4.7 TYPE GMP DI, GRATE TYPE 36R L+ 51.4 12" X 51.4' RCP BIOFILTRATION SWALES 12.2 ROCK CHECK DAMS BIOFILTRATION SWALES 425 BIOFILTRATION SWALES 388 697 425 TOTAL 1891 6.2 6.6 480.8 95.0 80.0 9.4 12.2 388 697 10.0 4.4 19.6 80 RELATIVE BORDER SCALE O
IS IN INCHES DRAWING No. UVAS CREEK BRIDGE NO. 37C0094 COUNTY OF SANTA CLARA ROADS AND AIRPORTS DEPARTMENT KP 10/22 CD 05 | 100% SUBMITTAL DQ-1 REPLACEMENT AT UVAS ROAD 04 95% SUBMITTAL REVISED KP 9/20 CD K. Panayotov 9/2020 Solomon Tegegne No. 76913 KP 3/18 CD 03 95% SUBMITTAL Solomon Tigigue
8E589C3D12854E2... DRAINAGE QUANTITIES R. Rameriz 9/2020 02 REV 65% SUBMITTAL KP 8/14 CD Rocelia kmak Barni Roncal 1/18/2023 Exp. 12/31/24 22 <sub>OF</sub> 39 KP 10/12 CD 01 65% SUBMITTAL B. Grimm BARNI RONCAL ASSISTANT CIVIL ENGINEER SOLOMON TEGEGNE SENIOR CIVIL ENGINEER ADVERTISEMENT DATE: CONTRACT No. ROCELIA KMAK PRINCIPAL CIVIL ENGINEER BY DATE APP'D AS SHOWN C4328 REVISIONS

### POST MILES SHEET TOTAL TOTAL PROJECT NO. SHEETS Dist COUNTY NOTES: STATIONARY MOUNTED CONSTRUCTION AREA SIGNS 23 04 SCI C.R. 1. THIS PLAN ACCURATE FOR STAGE CONSTRUCTION WORK ONLY. REGISTERED CIVIL ENGINEER DATE 2. LOCATION OF CONSTRUCTION AREA SIGNS ARE APPROXIMATE, SIGN CODE SIGN NUMBER OF POSTS NUMBER OF 11/30/22/ PANEL SIZE SIGN MESSAGE EXACT LOCATION WILL BE DETERMINED BY THE ENGINEER. No. AND SIZE SIGNS Carolyn D. Davis FEDERAL | CALIFORNIA 3. DRIVEWAY ACCESS TO BE MAINTAINED AT ALL TIMES. December 20, 2022 36" × 36" No. 58440 W20-1 ROAD WORK AHEAD 1 - 4" x 6" PLANS APPROVAL DATE 4. ABUTMENT 2 LEFT RETAINING WALL PORTION TO BE CONSTRUCTED (Exp. 12/31/24) IN STAGE 2. CONSTRUCTION DURING THIS STAGE MAY REQUIRE THE COUNTY OR ITS OFFICERS OR AGENTS SHALL NOT BE RESPONSIBLE FOR THE ACCURACY OR COMPLETENESS OF SCANNED COPIES OF THIS PLAN SHEET. 36" × 18" END OF ROAD WORK G20-2 1 - 4" × 6" CIVIL TEMPORARY SHORING. STOP R1-1 30" × 30" 1 - 4" × 6" 5. TEMPRARY RAILING TO HAVE REFLECTIVE MARKERS. 11017 COBBLEROCK DRIVE, QUINCY SUITE 100 ABBREVIATIONS: STOP AHEAD 1 - 4" × 6" W3 - 130" × 30" 2 RANCHO CORDOVA, CA 95670 ENGINEERING P: 916.368.9181 THERMOPLASTIC TRAFFIC STRIPE TTS TACC TEMPORARY ALTERNATIVE CRASH CUSHION Temp PAVEMENT MARKING (PAINT), LIMIT LINE PORTABLE CHANGEABLE MESSAGE SIGN CMS Exist BRIDGE PORTIONS TO BE REMOVED TACC — TACC PARCEL LINE Temp PAVEMENT MARKING REMOVE TTS — (PAINT), LIMIT LINE 45.96' L+ "A" 25+17.29 BEGIN Temp BAILING (TYPE K) 42.16' L+ "A" 24+51.94 END Temp RAILING (TYPE K) /**R**/**W** 250' – TÇE CONKORM -REMOVE TCE (27B) **R/W**-CONTRACTOR STAGING (0) /100\* A AREA 300' ′1000**ʻ** (B) TO SAN JOSE ---28 29 TCE creek DRAINAGE ×500′ EASEMENT $\subseteq R/W$ (A) \* -TACC $\bigcirc$ Br No. 3700600 TACC -(SEE STRUCTURE PLANS) 7.50'Rt "A" 27+57.23 END Temp RAILING (TYPE K) 22.65' Rt "A" 22+15.09 BEGIN Temp RAILING (TYPE K) LEGEND: CMS -"A" LINE STAGE 1 - CONSTRUCT ROADWAY AND BRIDGE, SEE NOTE 4 MORGAN HILL Exist \_UVAS Rd\_ WORK ZONE TEMPORARY RAILING (TYPE K) Min 24' 12' LANE 1 CHANNELIZERS (SURFACE MOUNTED) TEMPORARY PAVEMENT (No.) PROJECT LOCATION DELINEATION DETAIL NUMBER (TAPE) -2:1 Temp SLOPE TEMPORARY ALTERNATIVE CRASH CUSHION (TACC) O.45' HMA (TYPE A) - CMS Temp RAILING 0.70' CLASS 2 AB DIRECTION OF TRAFFIC (TYPE K) TEMPORARY PAVEMENT MARKING (PAINT) "STOP" **A** - **A** CONSTRUCTION AREA SIGNS STAGE 1 NO SCALE RELATIVE BORDER SCALE O IS IN INCHES DRAWING No. UVAS CREEK BRIDGE NO. 37C0094 COUNTY OF SANTA CLARA ROADS AND AIRPORTS DEPARTMENT 05 100% SUBMITTAL KP 10/22 CD SC-1 REPLACEMENT AT UVAS ROAD KP 9/20 CD 04 95% SUBMITTAL REVISED K. Panayotov 9/2020 Solomon Tegegne No. 76913 03 95% SUBMITTAL KP 3/18 CD Solomon tigigne 8E589C3D12854E2... STAGE CONSTRUCTION - STAGE 1 R. Rameriz 9/2020 02 REV 65% SUBMITTAL KP 8/14 CD Rocelia kmak Barni Roncal Exp. 12/31/24 23 <sub>OF</sub> 39 1/18/2023 01 65% SUBMITTAL KP 10/12 CD B51EF92B38F54B9. B. Grimm 9/2020 BARNI RONCAL ASSISTANT CIVIL ENGINEER SOLOMON TEGEGNE SENIOR CIVIL ENGINEER 1" = 50' ADVERTISEMENT DATE: CONTRACT No. ROCELIA KMAK PRINCIPAL CIVIL ENGINEER BY DATE C4328 REVISIONS

### NOTES:

- 1. THIS PLAN ACCURATE FOR STAGE CONSTRUCTION WORK ONLY.
- 2. LOCATION OF CONSTRUCTION AREA SIGNS ARE APPROXIMATE, EXACT LOCATION WILL BE DETERMINED BY THE ENGINEER.
- 3. DRIVEWAY ACCESS TO BE MAINTAINED AT ALL TIMES.
- 4. TEMPRARY RAILING TO HAVE REFLECTIVE MARKERS.
- 5. CONTRACTOR SHALL SUBMIT TRAFFIC HANDLING PLAN FOR STAGE 2.


### STATIONARY MOUNTED CONSTRUCTION AREA SIGNS

SIGN No.		N CODE	PANEL SIZE	SIGN MESSAGE	NUMBER OF POSTS AND SIZE	NUMBER OF SIGNS
	FEDERAL	CALIFORNIA				
А	W20-1		36" × 36"	ROAD WORK AHEAD	1 - 4" × 6"	2
В	G20-2		36" × 18"	END OF ROAD WORK	1 - 4" × 6"	2


Dist	COUNTY	ROUTE	POST MILES		TOTAL SHEETS
04	SCI	C.R.		24	39
D		er 20, 2	022	No. 58440	ENG INEER
THE COUNTY OR ITS OFFICERS OR AGENTS SHALL NOT BE RESPONSIBLE FOR THE ACCURACY OR COMPLETENESS OF SCANNED COPIES OF THIS PLAN SHEET.					
	<u> </u>	JINCY	11017 COE SUITE 100	BLEROCK DR	IVE,

ENGINEERING

SUITE 100 RANCHO CORDOVA, CA 95670 P: 916.368.9181

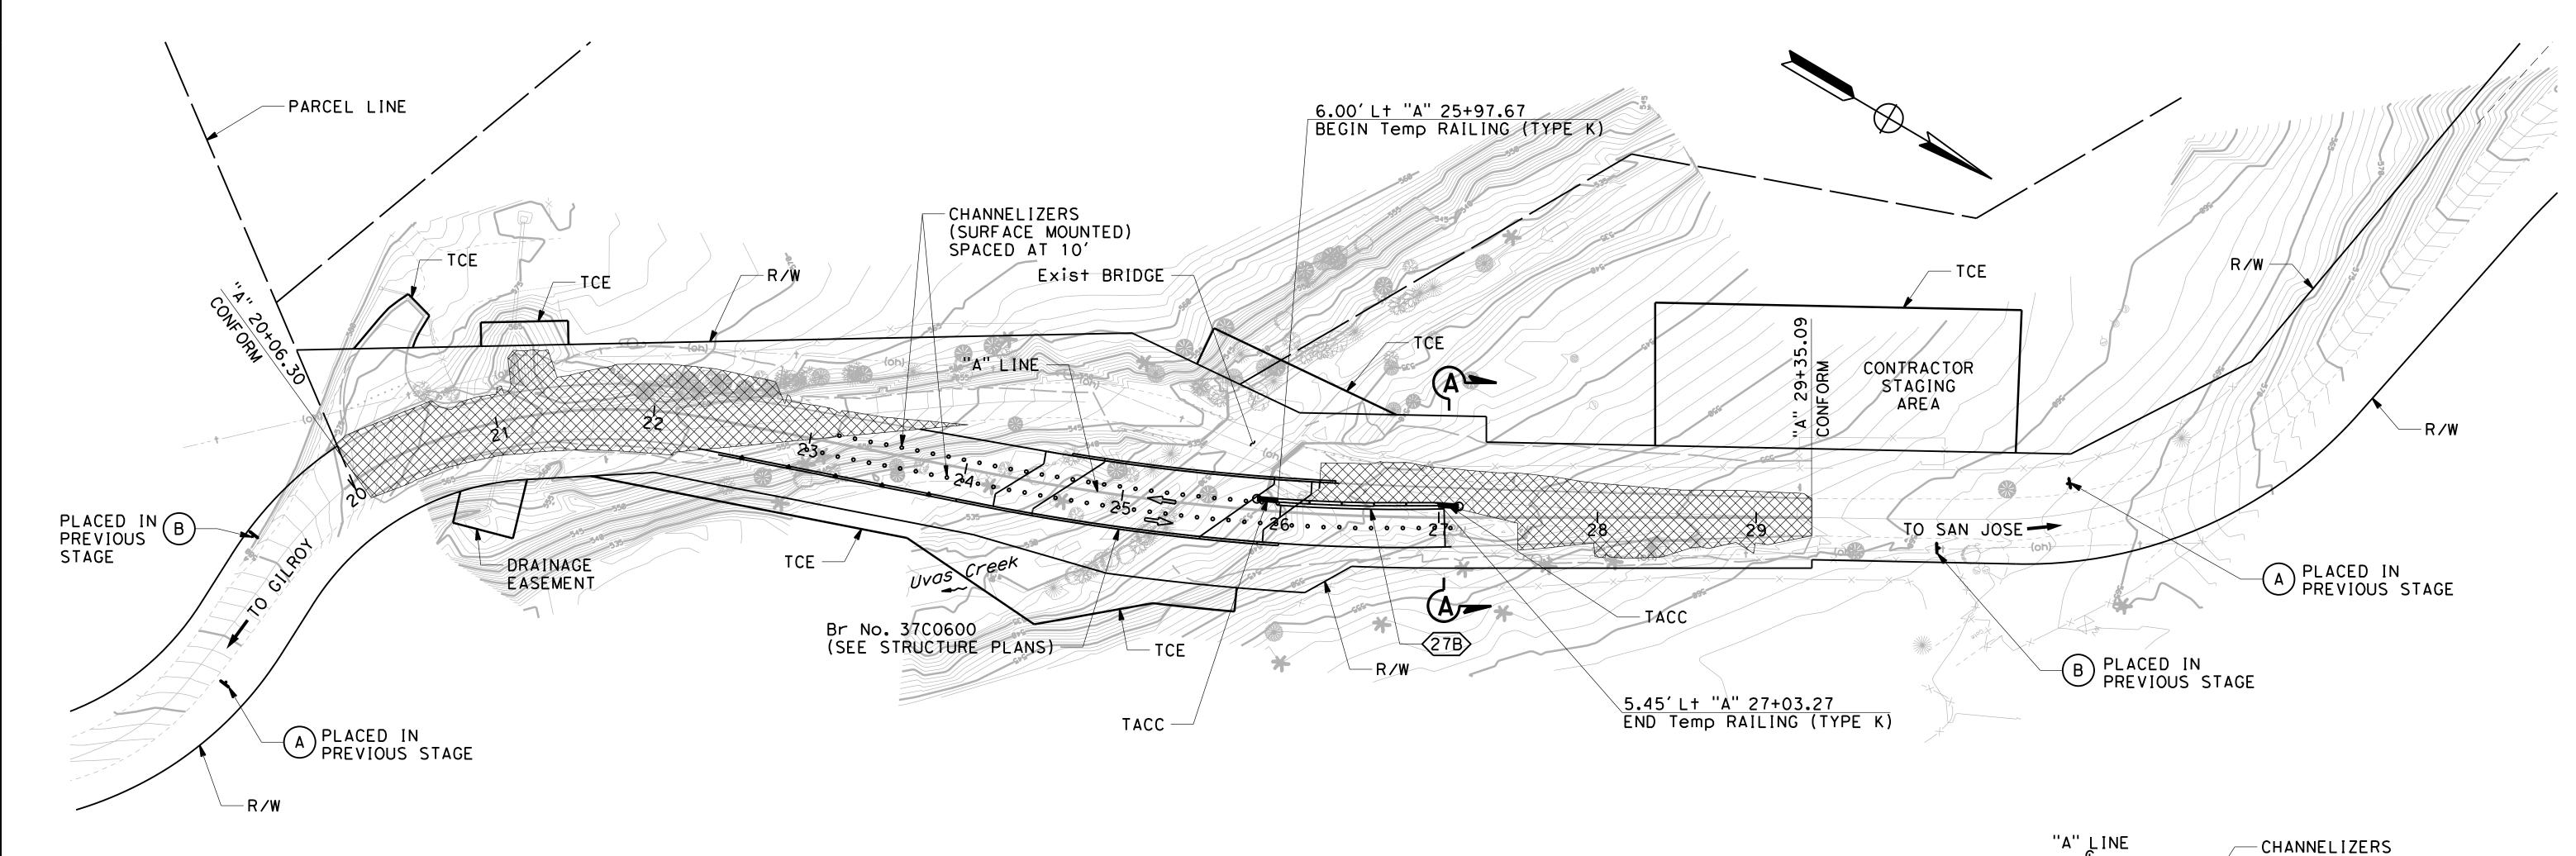

### LEGEND:

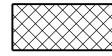

STAGE 2 - CONSTRUCT CONFORM AREAS UNDER TEMPORARY LANE CLOSURE.
CONSTRUCT ABUTMENT 2 LEFT RETAINING WALL PORTION.
FOR DETAILS, SEE STRUCTURE PLANS.

	"A" LINE CHANNELIZERS (SURFACE MOUNTED)
_ WORK ZONE	
	Tama DAII INC
O.45' HMA (TYPE A) O.70' CLASS 2 AB	Temp RAILING (TYPE K)
0.70' CLASS 2 AB	A A
	A - A
	CTACE 2

STAGE 2 NO SCALE

RELATIVE BORDER SCALE O IS IN INCHES

\Sant					
_		100% SUBMITTAL	KP	10/22	CD
i ent	04	95% SUBMITTAL REVISED	KP	9/20	CD
_ 	03	95% SUBMITTAL	KP	3/18	CD
S	02	REV 65% SUBMITTAL	KP	8/14	CD
<u>\</u>	01	65% SUBMITTAL	KP	10/12	CD
ILE	NO.	REVISIONS	BY	DATE	APP'D

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	DESIGNED
	R. Rame
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	K. Pa
	DESIGNED
	R. Ro
/ <sub>2</sub> \\	DRAWN
	IB.Gr

COUNTY OF SANTA CLARA ROADS AND AIRPORTS DEPARTMENT ayotov 9/2020 eriz 9/2020

Barni Roncal BARNI RONCAL ASSISTANT CIVIL ENGINEER

Rocelia kmak -- B51EF92B38F54B9. ROCELIA KMAK PRINCIPAL CIVIL ENGINEER

Solomon Tegegne No. 76913 Exp. 12/31/24 Solomon Tigigne
8E589C3D12854E2... 1/18/2023 SOLOMON TEGEGNE SENIOR CIVIL ENGINEER

UVAS CREEK BRIDGE NO. 37C0094 REPLACEMENT AT UVAS ROAD

ADVERTISEMENT DATE:

C4328

STAGE CONSTRUCTION - STAGE 2

CONTRACT No.

SC-2

DRAWING No.

24 <sub>OF</sub> 39 Scale 1" = 50'


### NOTES:

- 1. THIS PLAN ACCURATE FOR STAGE CONSTRUCTION WORK ONLY.
- 2. LOCATION OF CONSTRUCTION AREA SIGNS ARE APPROXIMATE, EXACT LOCATION WILL BE DETERMINED BY THE ENGINEER.
- 3. DRIVEWAY ACCESS TO BE MAINTAINED AT ALL TIMES.
- 4. TEMPRARY RAILING TO HAVE REFLECTIVE MARKERS.

### STATIONARY MOUNTED CONSTRUCTION AREA SIGNS

SIGN No.	SIGN CODE FEDERAL   CALIFORN		PANEL SIZE	SIGN MESSAGE	NUMBER OF POSTS AND SIZE	NUMBER OF SIGNS	
	ILDLIVAL	CALII OMNIA					
Α	W20-1		36" × 36"	ROAD WORK AHEAD	1 - 4" × 6"	2	
В	G20-2		36" × 18"	END OF ROAD WORK	1 - 4" × 6"	2	

Di	st	COUNTY	ROUTE	POST M TOTAL PE		SHEET No.	TOTAL SHEETS						
December 20, 2022  PLANS APPROVAL DATE  O4 SCI C.R.  25 3  11/30/22  PLANS APPROVAL DATE  D5 S8440  REGISTERED CIVIL ENGINEER  11/30/22  PLANS APPROVAL DATE  D5 S8440  REGISTERED CIVIL ENGINEER  11/30/22  PLANS APPROVAL DATE													
		SIQU	JINCY	7 11017 SUITE	COBBLER	OCK DR	IVE,						

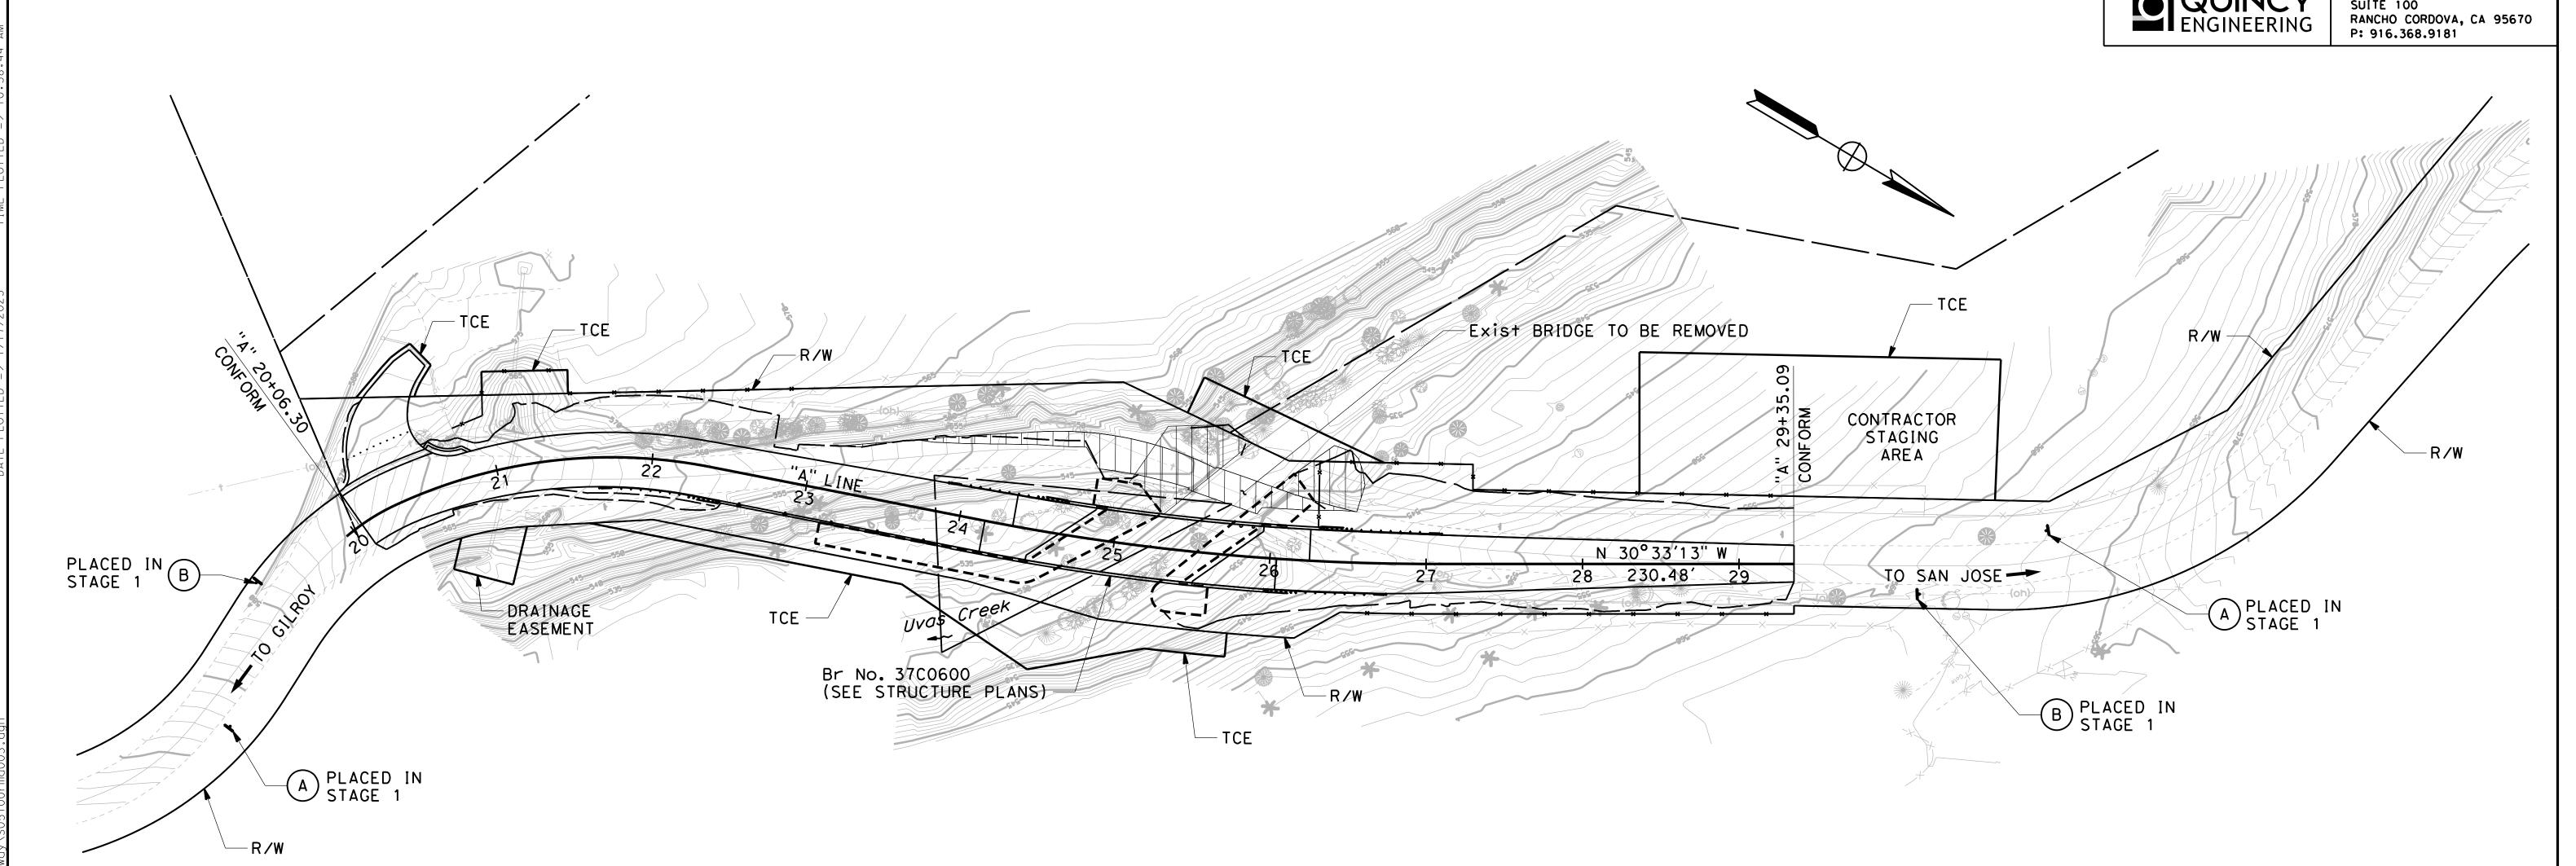

### LEGEND:

RELATIVE BORDER SCALE O

STAGE 3 - REMOVE EXISTING PAVEMENT AND BRIDGE, COMPLETE RSP PLACEMENT AND CONTOUR GRADING.

		IS IN INCHES			
\Santa					
_		100% SUBMITTAL	KP	10/22	CD
ent	04	95% SUBMITTAL REVISED	KP	9/20	CD
ر ا	03	95% SUBMITTAL	KP	3/18	CD
S	02	REV 65% SUBMITTAL	KP	8/14	CD
^ II	01	65% SUBMITTAL	KP	10/12	CD
H L	NIO	REVISIONS	DV	DATE	ADD'N

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COUNT	Y OF	SANTA	CLARA	ROADS	AND	AIRPORTS
		SUBMITTED:		REVIEWED:		APPROVED:
nayotov	9/2020					DocuSi
	DATE					Solom
meriz	9/2020	DocuSigned by:	1	Rowlia	•	8E589C
		II Main. 1 VAI. 1 al	I	1 1000000	V-1-1000C	

BARNI RONCAL ASSISTANT CIVIL ENGINEER

B51EF92B38F54B9...

ROCELIA KMAK PRINCIPAL CIVIL ENGINEER

APPROVED:  ROFESS 10NA  Concessioned by:	AIRP(	ORTS DE	PART	MENT
SOLOMON TEGEGNE  SOLOMON TEGEGNE  SOLOMON TEGEGNE  SOLOMON TEGEGNE  SENIOR CIVIL ENGINEER  SOLOMON TEGEGNE   _	DocuSigned by:  Solomon Trans 8E589C3D12854E2  1/18/202	38 SE	Solomon Tegegne No. 76913 Exp. 12/31/24	

UVAS	CREEK	BRIDGE	NO.	<b>37COO9</b>	4	
RE	PLACEME	ENT AT	UVAS	ROAD		
STAGE	CONST	RUCT	ON	- STA	4GE	3

CONTRACT No.

ADVERTISEMENT DATE:

C4328

			_
•	A C E 7		
	AGE 3	SHT No. <b>25</b> OF	39
	FILE No.	Scale	

Dist| COUNTY 04 REGISTERED CIVIL ENGINEER DATE

· 	ROADWAY ITEMS																							
	FROM		ТО	ROADWAY EXCAVATION	EMBANKMENT (N)	IMPORTED BORROW	CLASS 2 AGGREGATE BASE	HOT MIX ASPHALT (TYPE A)	PLACE HMA DIKE (TYPE A)	PLACE HMA DIKE (TYPE C)	PLACE HMA DIKE (TYPE E)	PLACE HMA DIKE (TYPE F)	MINOR CONCRETE (MINOR STRUCTURE)	REMOVE FENCE	TEMPORARY FENCE (TYPE CL-6)	ROADSIDE SIGN - ONE POST	REMOVE ROADSIDE SIGN	DELINEATOR (CLASS 1)	REMOVE MARKER	REMOVE GUARDRAIL	AC J	ROCK SLOPE PROTECTION (1/2 TON, CLASS VII, METHOD B)	GRAVEL FILTER	COMMENTS
LIN	E STATION	LINE	STATION	CY	CY	CY	CY	TON	LF	LF	LF	LF	CY	LF	LF	ΕA	EΑ	EΑ	EΑ	LF	CY	CY	CY	
"A'	20+06.63	"A"	24+64.30 BB	1583	2606	1023	401	525	30	82	119	24	6.2	455	283			12			116			CONCRETE VALLEY GUTTER
"A'	25+74.30 EB	"A"	29+35.09	344	1951	1607	272	357		70		31		681	598									L
"A'	20+18.77	"A"	20+56.91	36	0	- 36	32	37																RECONSTRUCT DRIVEWAY
"A'	DS 1 INVERT	"A"	21+20.00 L+	13	0	-13																		CONTOUR GRADING
"A'	ABUTMENT 1			326	317	-9																505.3	84.7	CONTOUR GRADING/RSP
"A'	ABUTMENT 2			86	306	220																282.0	47.2	CONTOUR GRADING/RSP
"A'	24+50.00 L†															1								ROADSIDE SIGN - ONE POST
"A'	26+10.00 R+															1								ROADSIDE SIGN - ONE POST
"A'	20+68.00 R+																1							REMOVE ROADSIDE SIGN
"A'	21+70.00 R+																1							REMOVE ROADSIDE SIGN
"A'	27+47.00 L+																1							REMOVE ROADSIDE SIGN
"A'	29+30.00 L†																1							REMOVE ROADSIDE SIGN
	EXIST BRIDGE	BB L+																	1	32				EXIST BRIDGE
	EXIST BRIDGE	BB R+																	1	50				EXIST BRIDGE
	EXIST BRIDGE	EB L+																	1	51				EXIST BRIDGE
	EXIST BRIDGE	EB Rt																	1	51				EXIST BRIDGE
	•		TOTAL	2398	5180	2792	705	919	30	152	119	55	6.2	1136	881	2	4	12	4	184	116	787.3	131.9	

GUARD RAILING FROM TO ALTERNATI IN-LINE TERMINAL SYSTEM TRANSITI RAILING (TYPE WB-31) FROM OFFSET LINE EΑ "A" 22+20.40 19.80 R+ "A" 21+67.26 18.77 R+ "A" 22+20.40 19.80 Rt "A" 22+45.00 20.00 Rt 1 "A" 23+90.64 19.21 L+ 24+40.64 20.00 L+ "A" 24+40.64 20.00 L† 24+65.64 20.00 L+ "A" 26+34.00 20.00 L+ "A" 26+57.93 19.85 L+ "A" 26+57.93 19.85 L+ "A" 27+08.54 18.55 L+ "A" 25+98.30 20.00 R† "A" 26+23.30 19.92 R+ "A" 26+73.30 19.26 R+ "A" 26+23.30 19.92 Rt

					TOTAL 4					4	4	
	PAVEMENT DELINEATION										PAVEME	NT
FROM			ТО	THERMOPLASTIC TRAFFIC STRIPE				RIPE	MARKE (RFTR)	R )-		
IINF	STATION	OFFSFT	    INF	STATION	OFFSFT	DETAIL			THERMO	PLASTIC	REFLECT	IVE)
-	5 17 101			STATION		No.	FT	FT			EΑ	
"A"	20+06.63		"A"	29+35.09		22		1857			156	
"A"	20+06.63	LT	"A"	24+34.23	LT	39	437					
"A"	24+34.23	LT	"A"	26+25.29	LT	39			19	90		
"A"	26+25.29	LT	"A"	29+35.09	LT	39	309					
"A"	20+06.63	RT	"A"	24+16.27	RT	39	399					
"A"	24+16.27	RT	''A''	26+04.23	RT	39			19	90		
"A"	26+04.23	LT	"A"	29+35.09	RT	39	332					
	SUBTOTAL TOTAL						1477	1857				
	TOTAL						33	334	38	30	156	


ADVERTISEMENT DATE:

C4328

					TRAFFIC	CONT	ROL					
SHEET No.	STAGE		FROM	TO		TEMPORARY RAILING (TYPE K)	TEMPORARY ALTERNATIV CRASH CUSH	CHANNELIZERS (SURFACE MOUNTED)	TEMPOR PAVEME MARKIN (PAINT)	TEMPORARY TRAFFIC STRIPE (TAPE)	REMOVE THERMOPLAS TIC TRAFFIC STRIPE	DESCRIPTION
		LINE	STATION	LINE	STATION	LF	EΑ	EΑ	SQFT	LF	LF	
SC-1	1	"A"	22+15.09 Rt	"A"	24+51.94 L+	240	2			240		
	1	"A"	25+17.29 L†	"A"	27+57.23 Rt	240	2			240		
	1	"A"	24+00.00 L†	"A"	24+67.71 L†						35	
	1	"A"	26+79.41 L+	"A"	27+60.00 L+						80	
	1	"A"	24+21.00 L†						22			"STOP"
	1	"A"	24+33.00 L†						11			LIMIT LINE
	1	"A"	27+59.00 L†						11			LIMIT LINE
	1	"A"	27+72.00 L†						22			"STOP"
SC-2	2	"A"	25+97.67 L†	"A"	27+03.27 L+	100	2			100		
	2	"A"	23+00.00 L+/R+	"A"	27+07.00 L+/R+			71				
SC-3	3	"A"		"A"								
		TOTAL 580 6 71 66 580 115									115	


	RELATIVE BORDER SCALE <sup>0</sup> 1 2 IS IN INCHES L 1 1 1 1	3		
05	100% SUBMITTAL	KP	10/22	CE
04	95% SUBMITTAL REVISED	KP	9/20	C
03	95% SUBMITTAL	KP	3/18	C[
02	REV 65% SUBMITTAL	KP	8/14	C
01	65% SUBMITTAL	KP	10/12	C[
NO.	REVISIONS	BY	DATE	APP

(N) NOT A SEPARATE PAY ITEM, FOR INFORMATION ONLY.

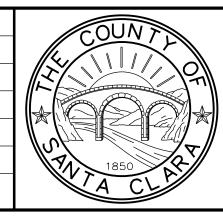

	COUNT	Y OF	SANTA	CLARA	ROADS	AND	AIRPORT	S DEPA	ARTMENT
$\setminus$	K. Panayotov  DESIGNED	9/2020 DATE	SUBMITTED:		REVIEWED:			uSigned by:	Solomon Tenenne
<i>y</i>	R. Romeriz  DRAWN B. Grimm	9/2020 DATE 9/2020	DocuSigned by:  Barni Roncal  77061EF45E4643E		Rowia t	zmak		by Discourage (1903) 12854E2 1/18/2023	Tegegne No. 76913 Exp. 12/31/24 CIVIL

Roculia Emak DATE BARNI RONCAL ASSISTANT CIVIL ENGINEER ROCELIA KMAK PRINCIPAL CIVIL ENGINEER

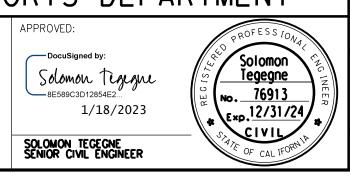

UVAS	CREEK	BRI	DGE	NO.	3700094
REF	PLACEME	ENT	ΑT	UVAS	ROAD
					'

Q-1

SUMMARY OF QUANTITIES

CONTRACT No.

26 <sub>OF</sub> 39 Scale AS SHOWN

POST MILES SHEET TOTAL TOTAL PROJECT No. SHEETS

December 20, 2022

THE COUNTY OR ITS OFFICERS OR AGENTS SHALL NOT BE RESPONSIBLE FOR THE ACCURACY OR COMPLETENESS OF SCANNED COPIES OF THIS PLAN SHEET.

PLANS APPROVAL DATE

26


Carolyn D. Davis

No. 58440 Exp. 12/31/24/


11017 COBBLEROCK DRIVE,

RANCHO CORDOVA, CA 95670 P: 916.368.9181

SUITE 100

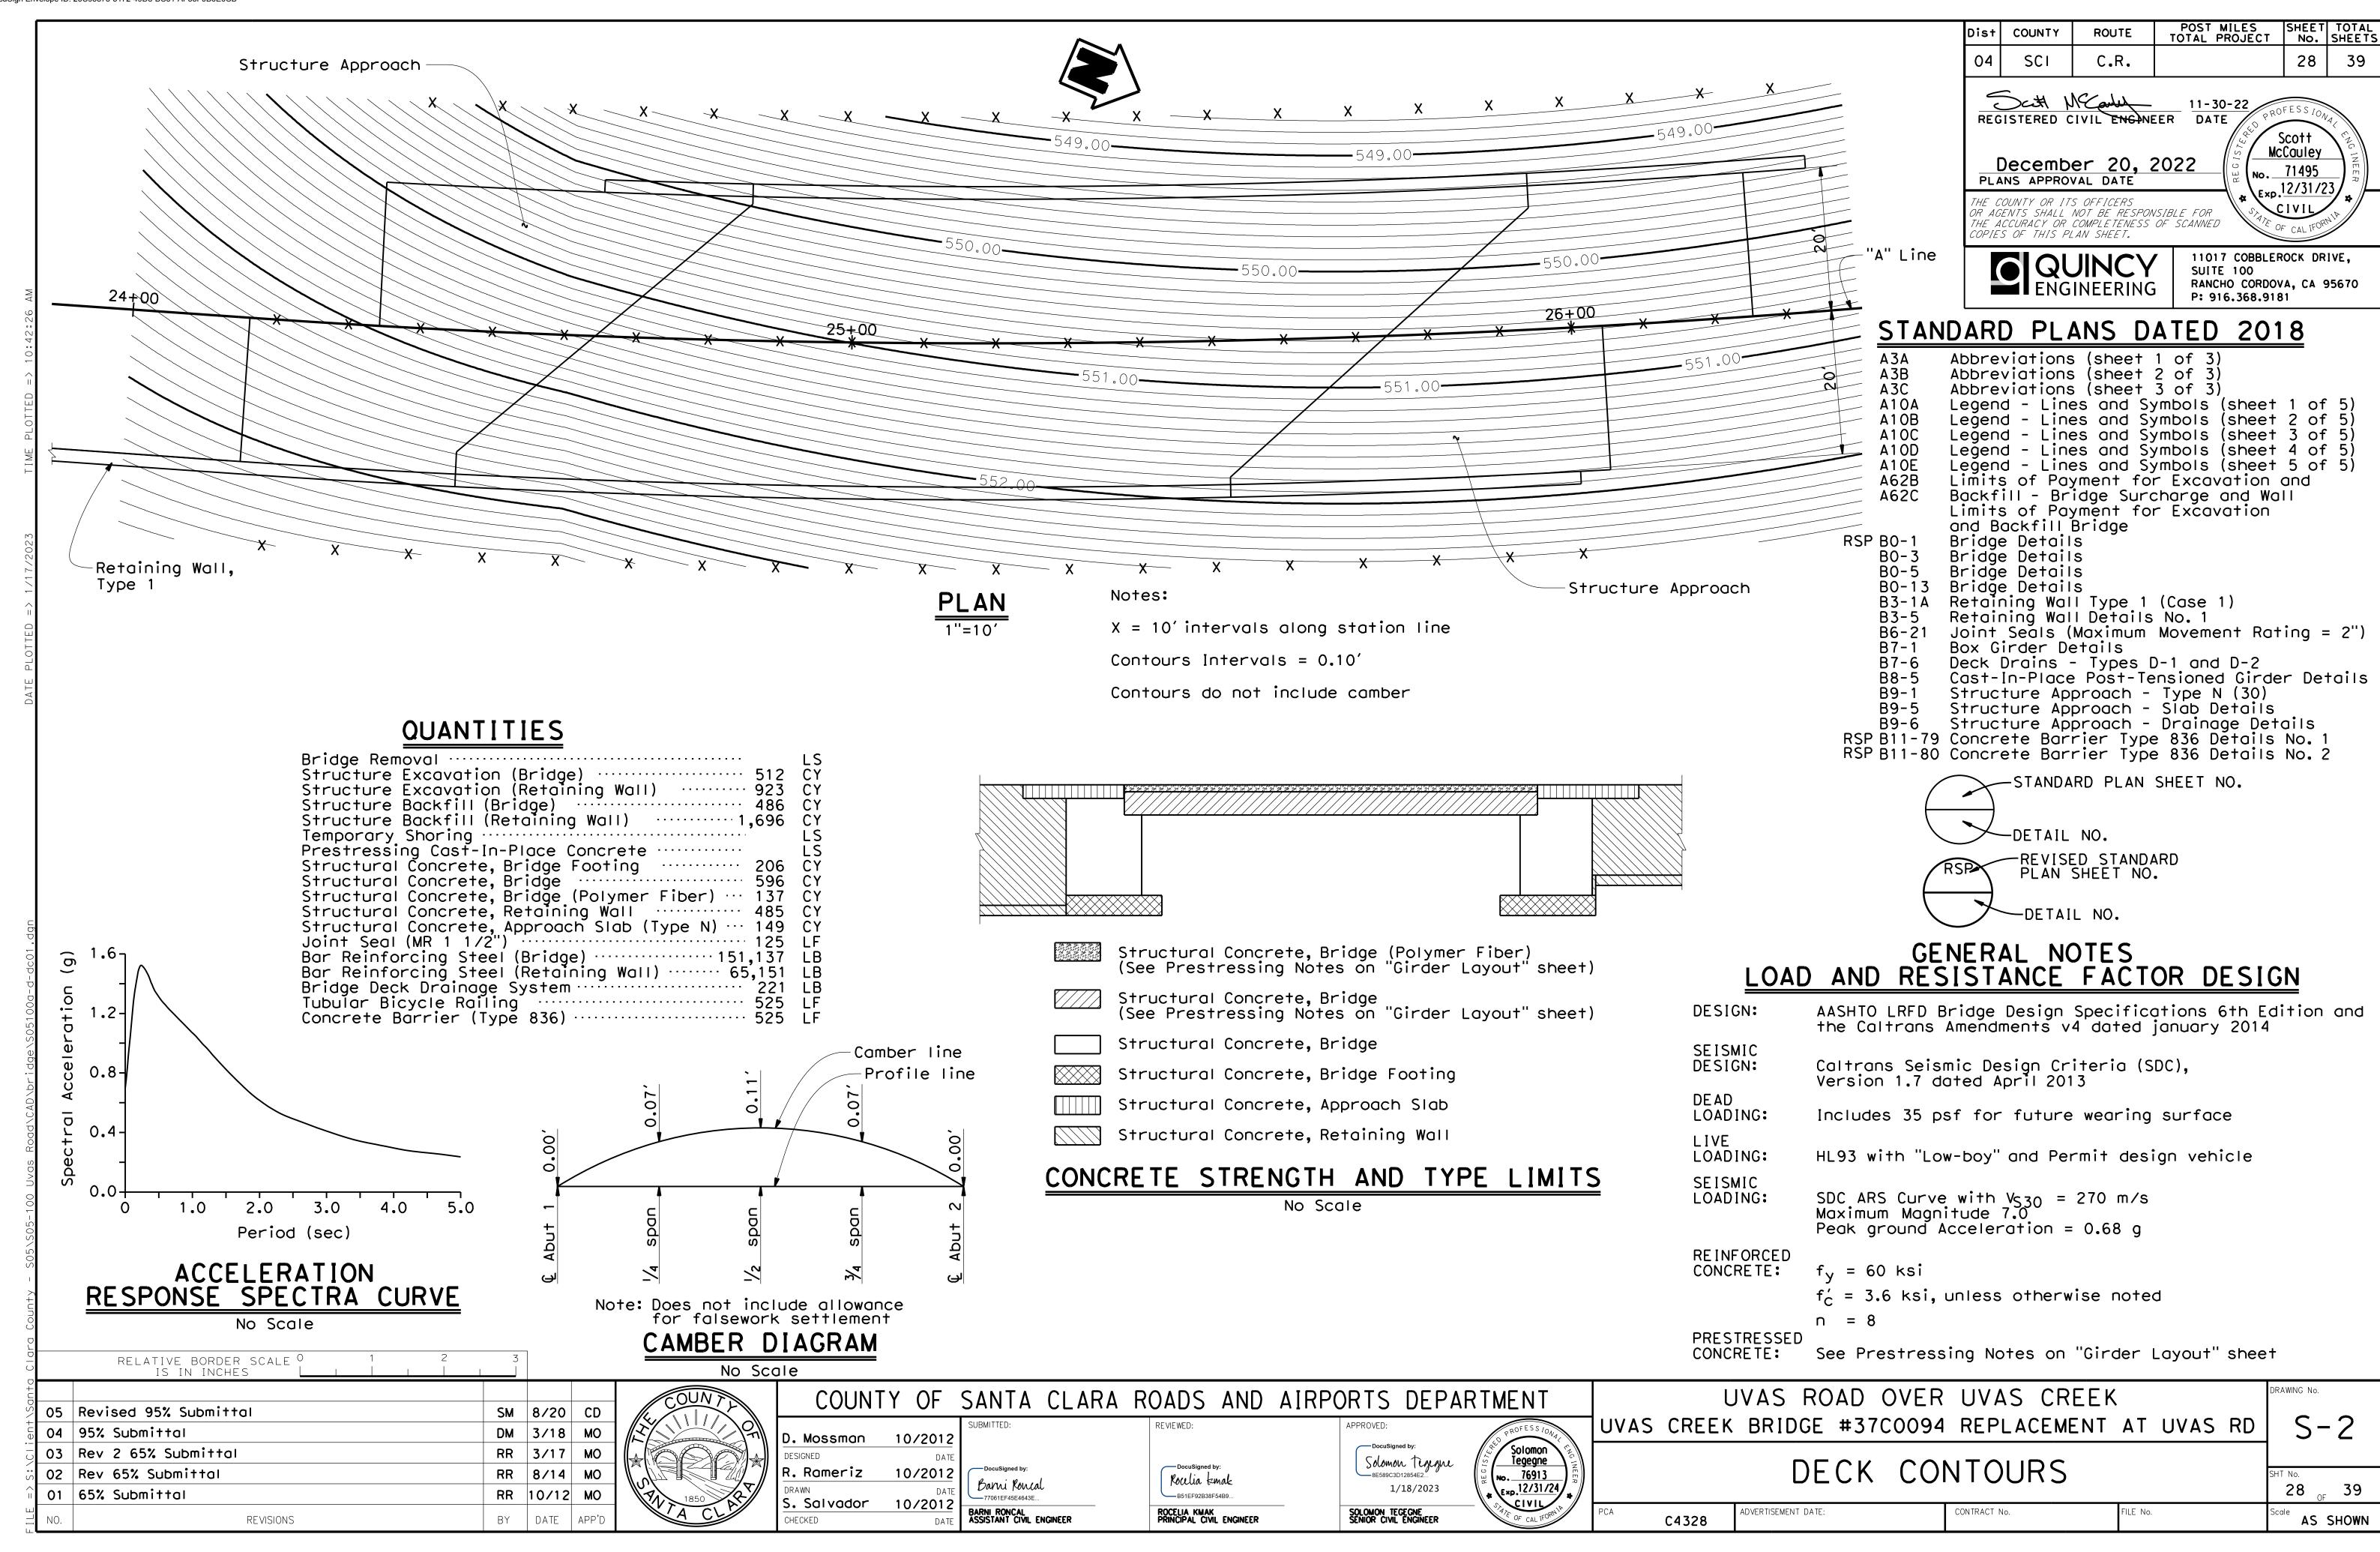



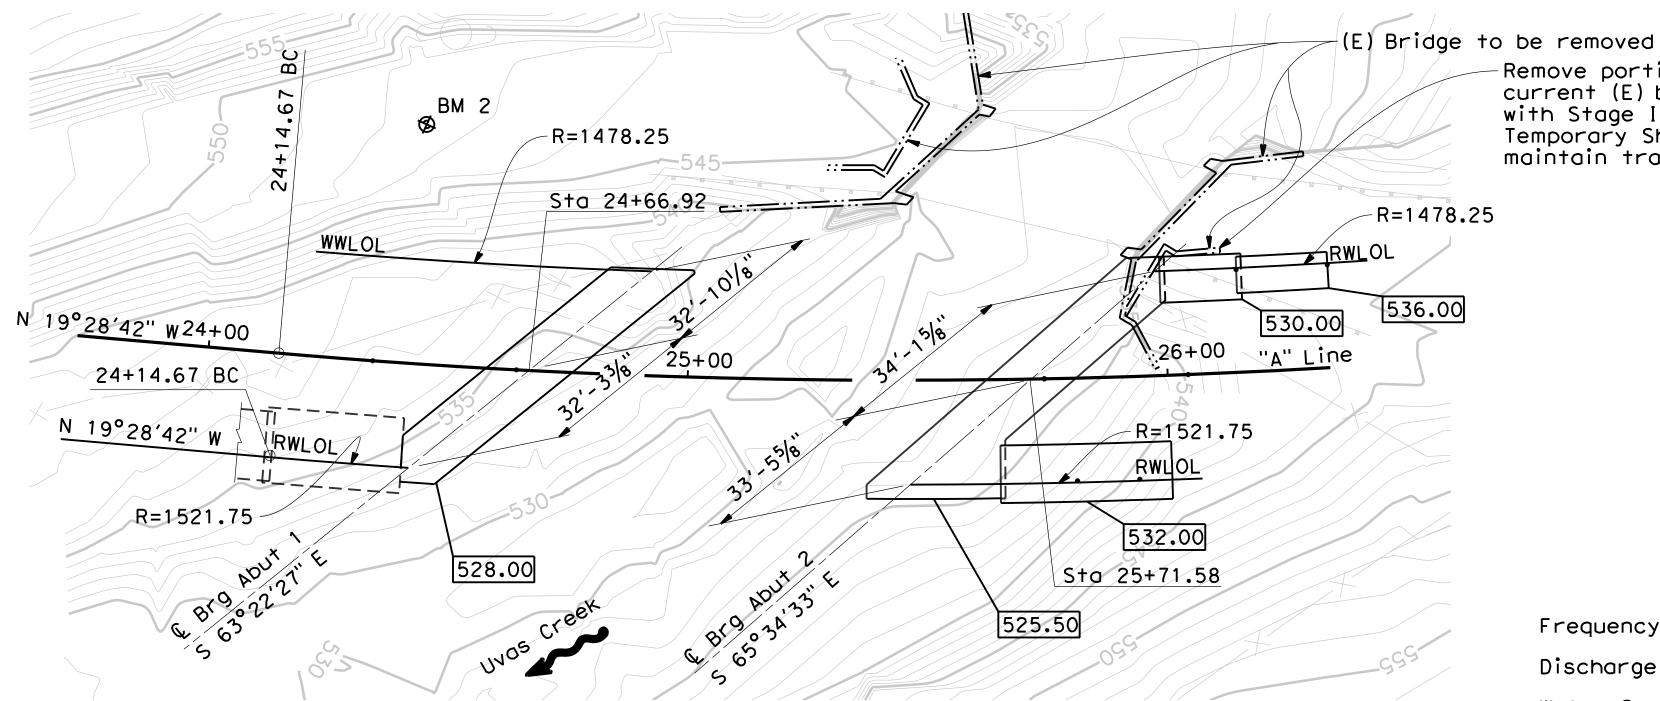

**PLAN** 

BENCH MARK DATA

No.	NORTHI NG	EASTING	ELEVATION	LINE	STATION	OFFSET	DESCRIPTION
1	1861703.04	6204767.81	565.29	" A"	21+15.46	9.35′R+	Iron Pipe 1"
2	1861977.30	6204584.79	547.51	" A"	24+42.15	49.89′L+	Iron Pipe 1"
3	1862270.18	6204487.16	549.68	" A"	27+54.01	7.23′L+	Iron Pipe 1"

Horizontal Datum: Zone 3 CSPC NAD83 Vertical Datum: NAVD88

BY DATE

## SPREAD FOOTING DATA TABLE

LOCATION	SERVICE PERMISSABLE NET CONTACT STRESS (SETTLEMENT) (ksf)	STRENGTH/CONSTRUCTION FACTORED GROSS NOMINAL BEARING RESISTANCE Øb = 0.5 (ksf)	EXTREME EVENT FACTORED GROSS NOMINAL BEARING RESISTANCE Øb = 1.0 (ksf)
ABUT 1	22.2	37.5	68.2
ABUT 2	21.3	33.3	60.6

Remove portions of old and current (E) bridge in conflict with Stage I construction.
Temporary Shoring required to maintain traffic.

	Dist	COUNTY	ROUTE		MILES PROJECT	SHEET No.	TOTAL SHEETS	
	04	SCI	C.R.			29	39	
	THE CONTINUES OF LESS 100 A TO SELECTION AND THE PROPERTY OF LIFE AND THE PROPERTY OF LI							
	THE COUNTY OR ITS OFFICERS OR AGENTS SHALL NOT BE RESPONSIBLE FOR THE ACCURACY OR COMPLETENESS OF SCANNED COPIES OF THIS PLAN SHEET.							
·	ENGINEERING  11017 COBBLEROCK DRIVE SUITE 100 RANCHO CORDOVA, CA 95 P: 916.368.9181						·	

## HYDROLOGIC SUMMARY

Drainage area: 14.20 Square Miles

Design Base <u>Flood</u> Flood Frequency (years) 100 Discharge (cubic feet per second) 5,260 Water Surface Elev at Bridge (ft) 540.0 540.5

Flood plain data based upon information available when the plans were prepared and are shown to meet Federal requirments. The accuracy of said information is not warranted by the County and interested or affected parties should made their own investigations.

### SCOUR DATA TABLE

SUPPORT No.	LONG TERM (DEGRADATION AND CONTRACTION) SCOUR ELEVATION (f+)	SHORT TERM (LOCAL) SCOUR DEPTH (f+)
Abut 1	535.60	3.8
Abut 2	534.60	5.7

Legend:

ADVERTISEMENT DATE:

C4328

Indicates bottom of footing elevation

RELATIVE BORDER SCALE O
IS IN INCHES 05 Revised 95% Submittal SM 8/20 CD DM 3/18 MO 04 95% Submittal 03 Rev 2 65% Submittal RR 3/17 MO 02 Rev 65% Submittal RR 8/14 MO 01 65% Submittal RR 10/12 MO

REVISIONS



D. Mossman

COUNTY OF SANTA CLARA ROADS AND AIRPORTS DEPARTMENT 10/2012

R. Rameriz 10/2012 Barni Roncal S. Salvador 10/2012 BARNI RONCAL ASSISTANT CIVIL ENGINEER

Pocusigned by:
Rowlia Emak ROCELIA KMAK PRINCIPAL CIVIL ENGINEER

Solomon Tegegne No. 76913 Solomon tigigne
8E589C3D12854E2... 1/18/2023 SOLOMON TEGEGNE SENIOR CIVIL ENGINEER

UVAS ROAD OVER UVAS CREEK UVAS CREEK BRIDGE #37C0094 REPLACEMENT AT UVAS RD

FOUNDATION PLAN

CONTRACT No.


29 <sub>OF</sub> 39


S-3


DRAWING No.


AS SHOWN


Exp. 12/31/24

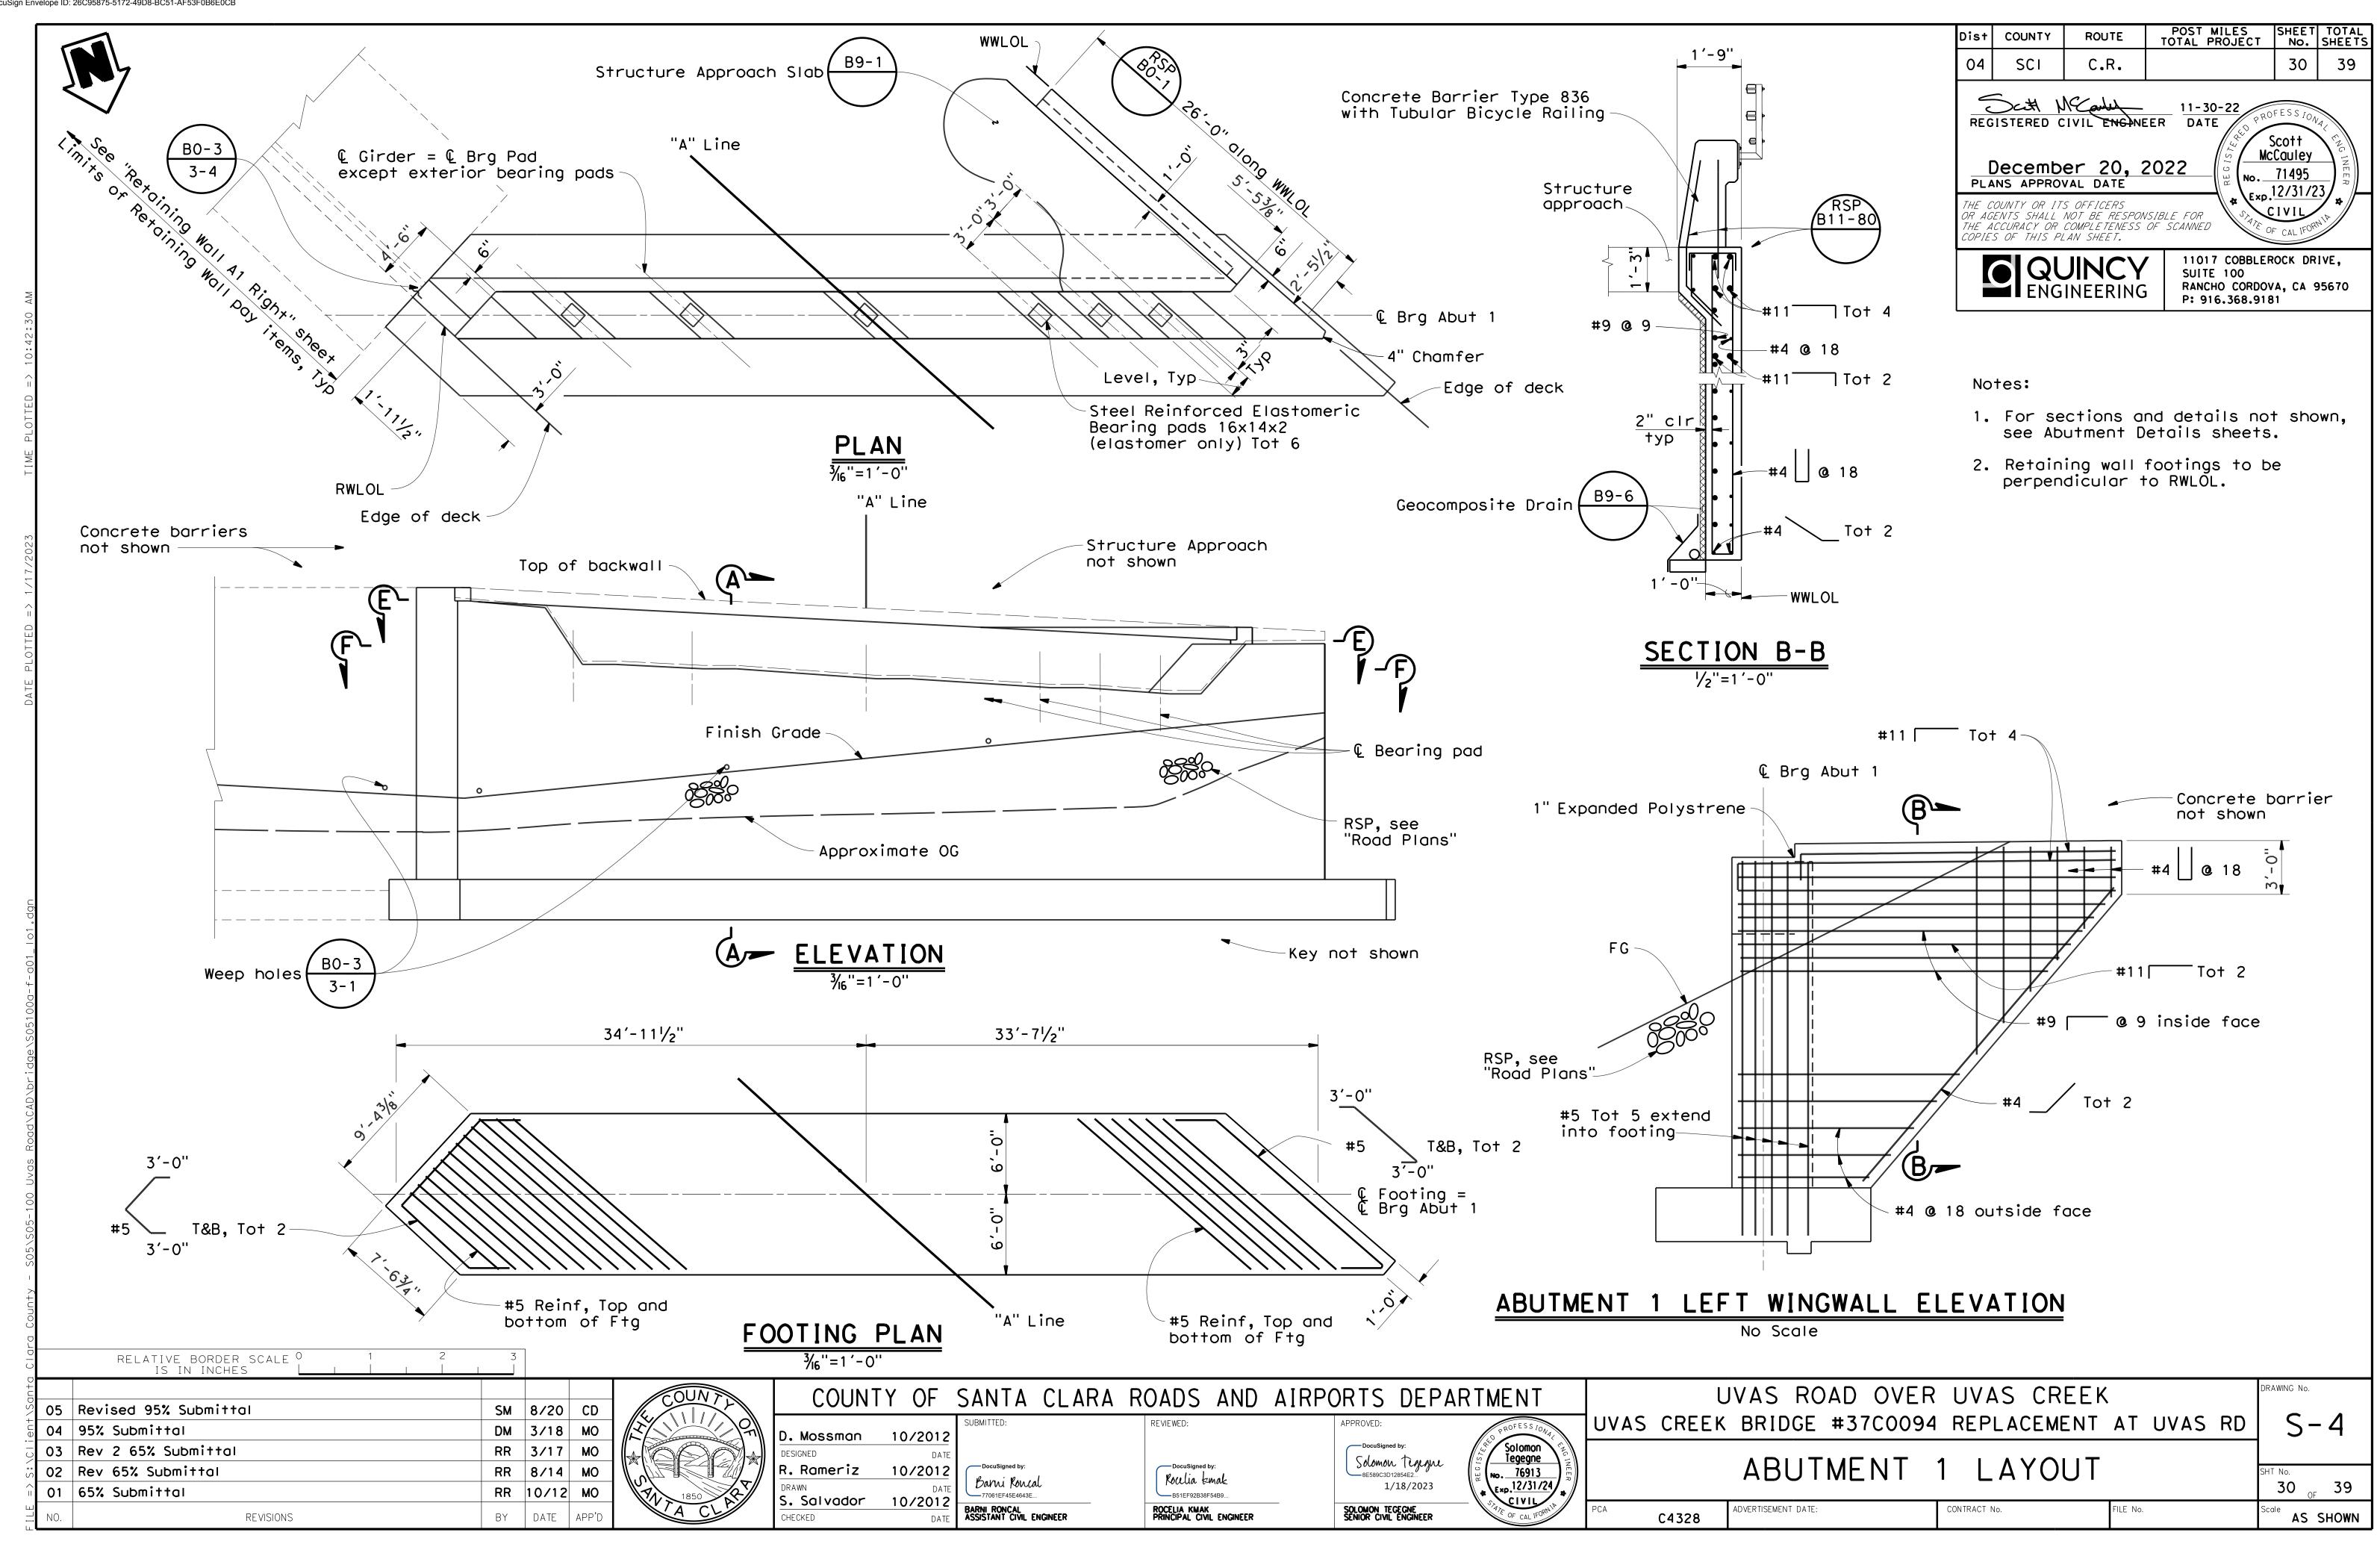


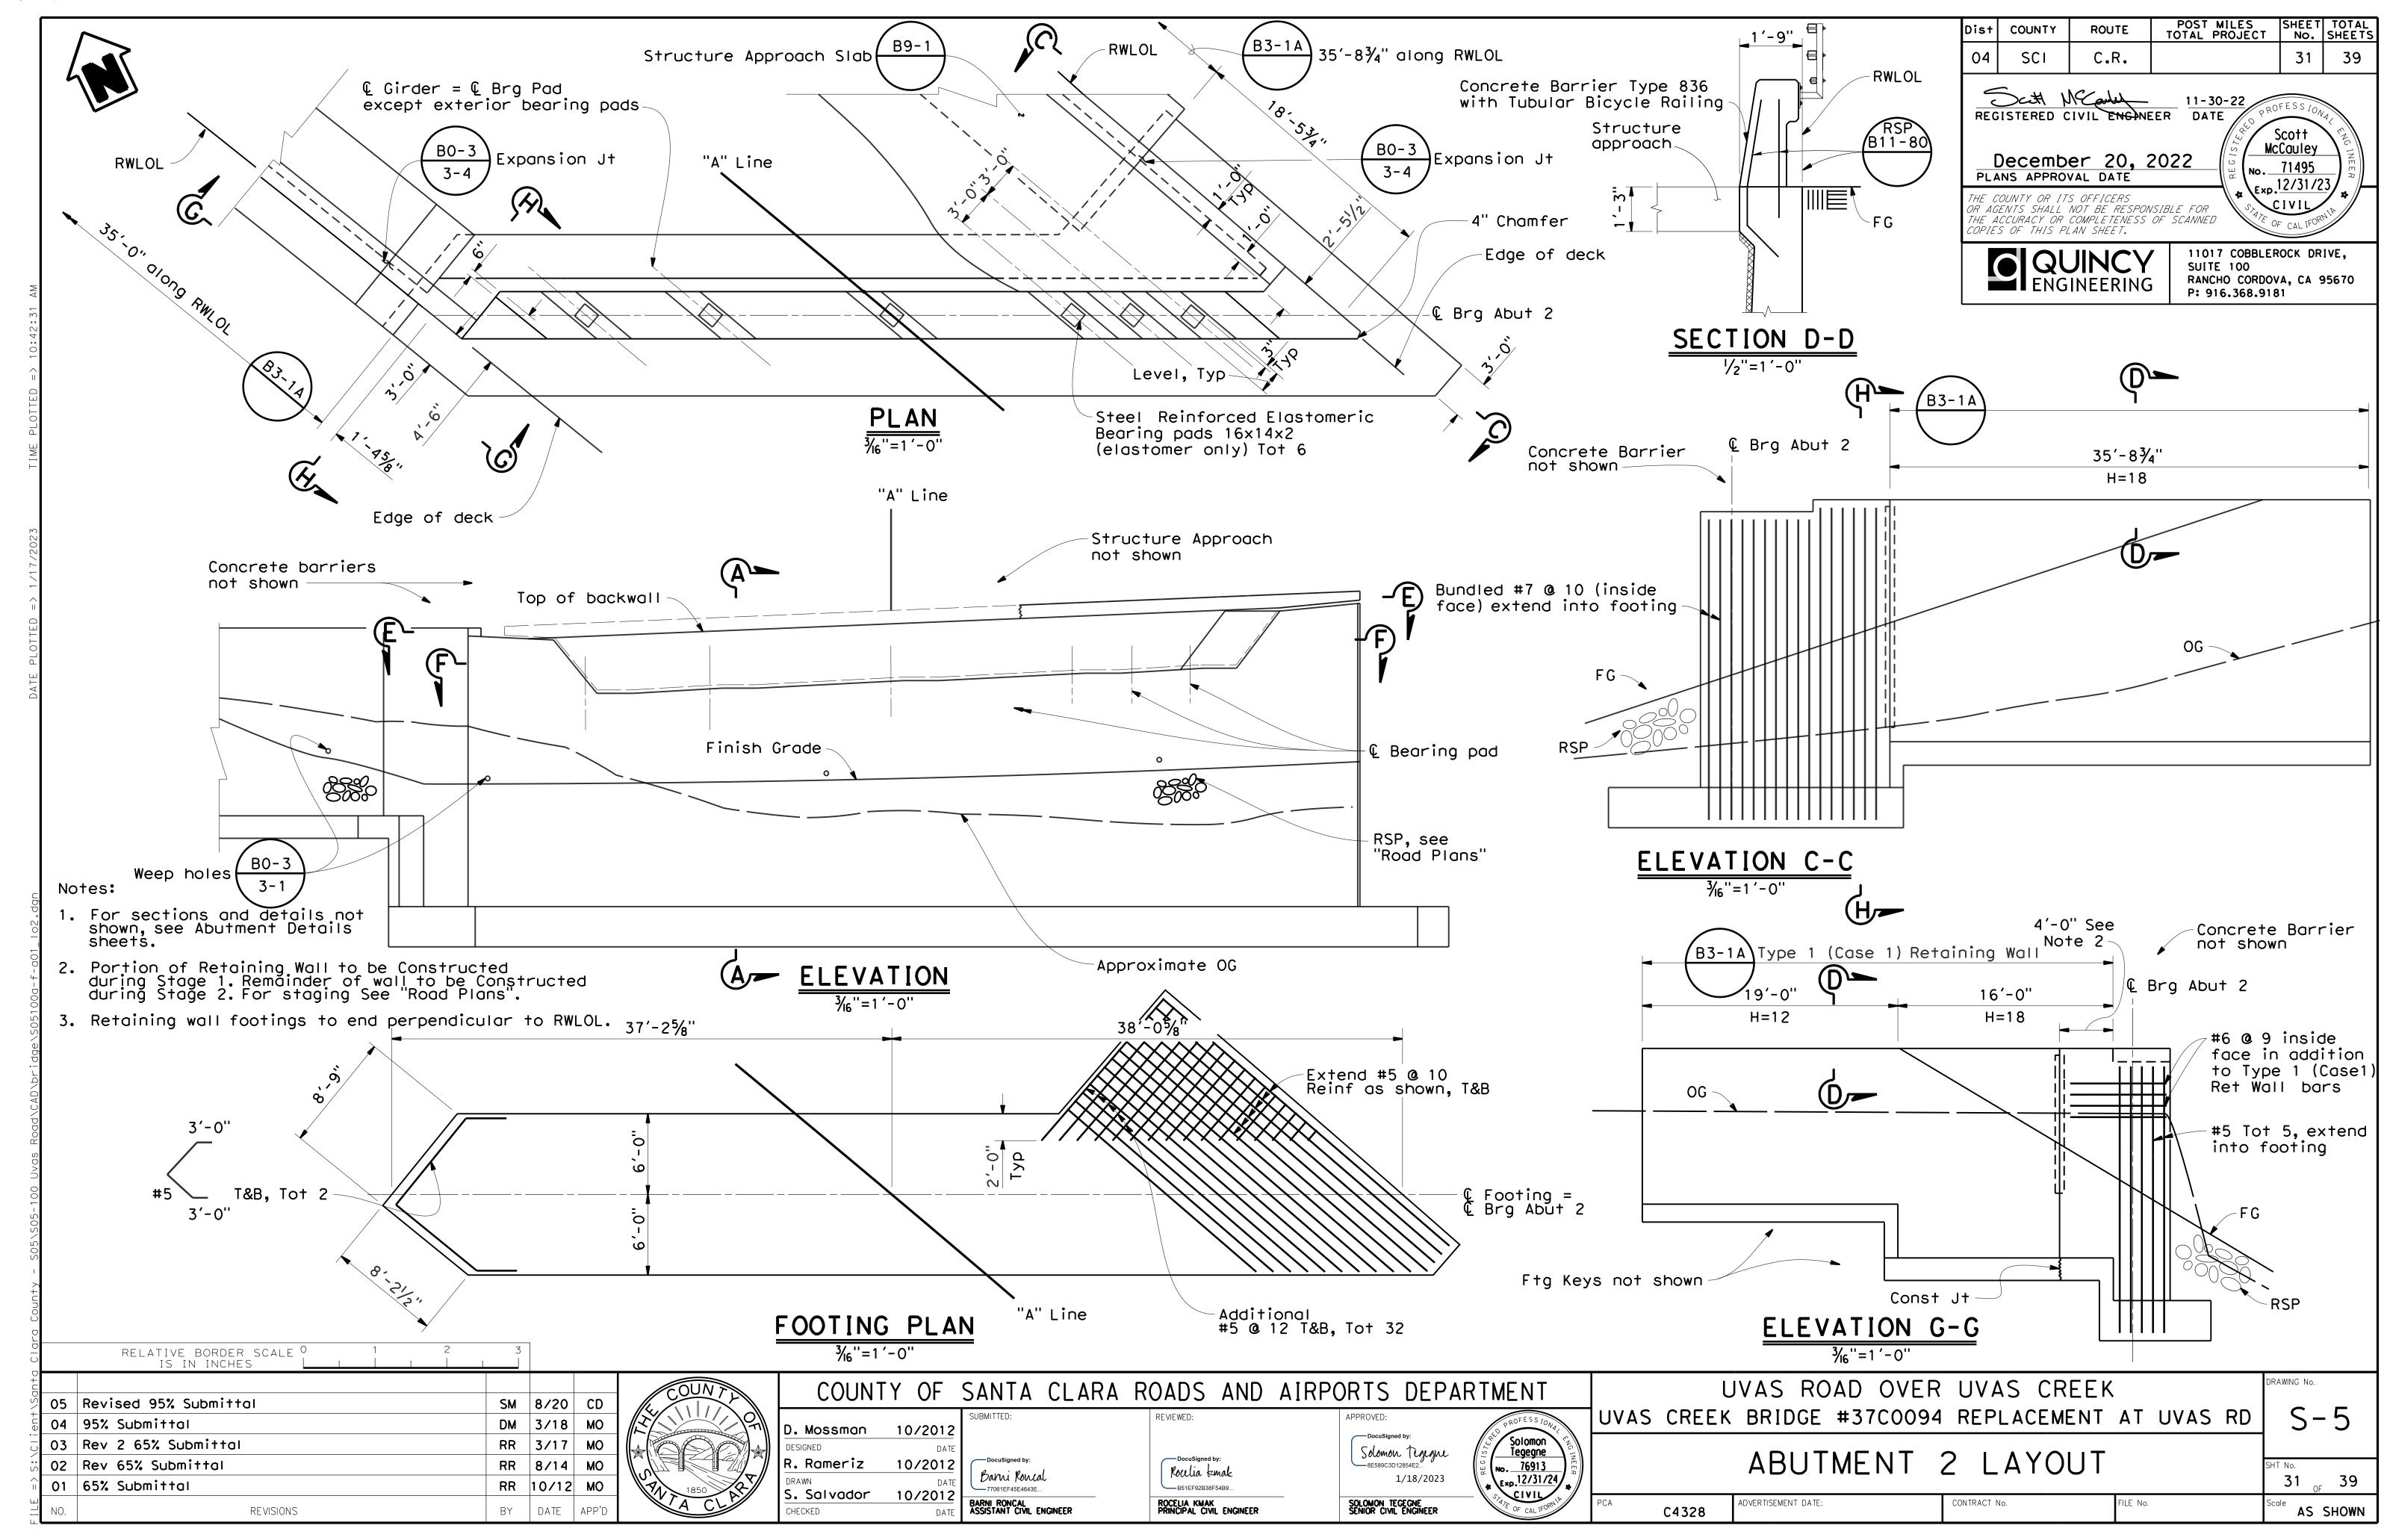


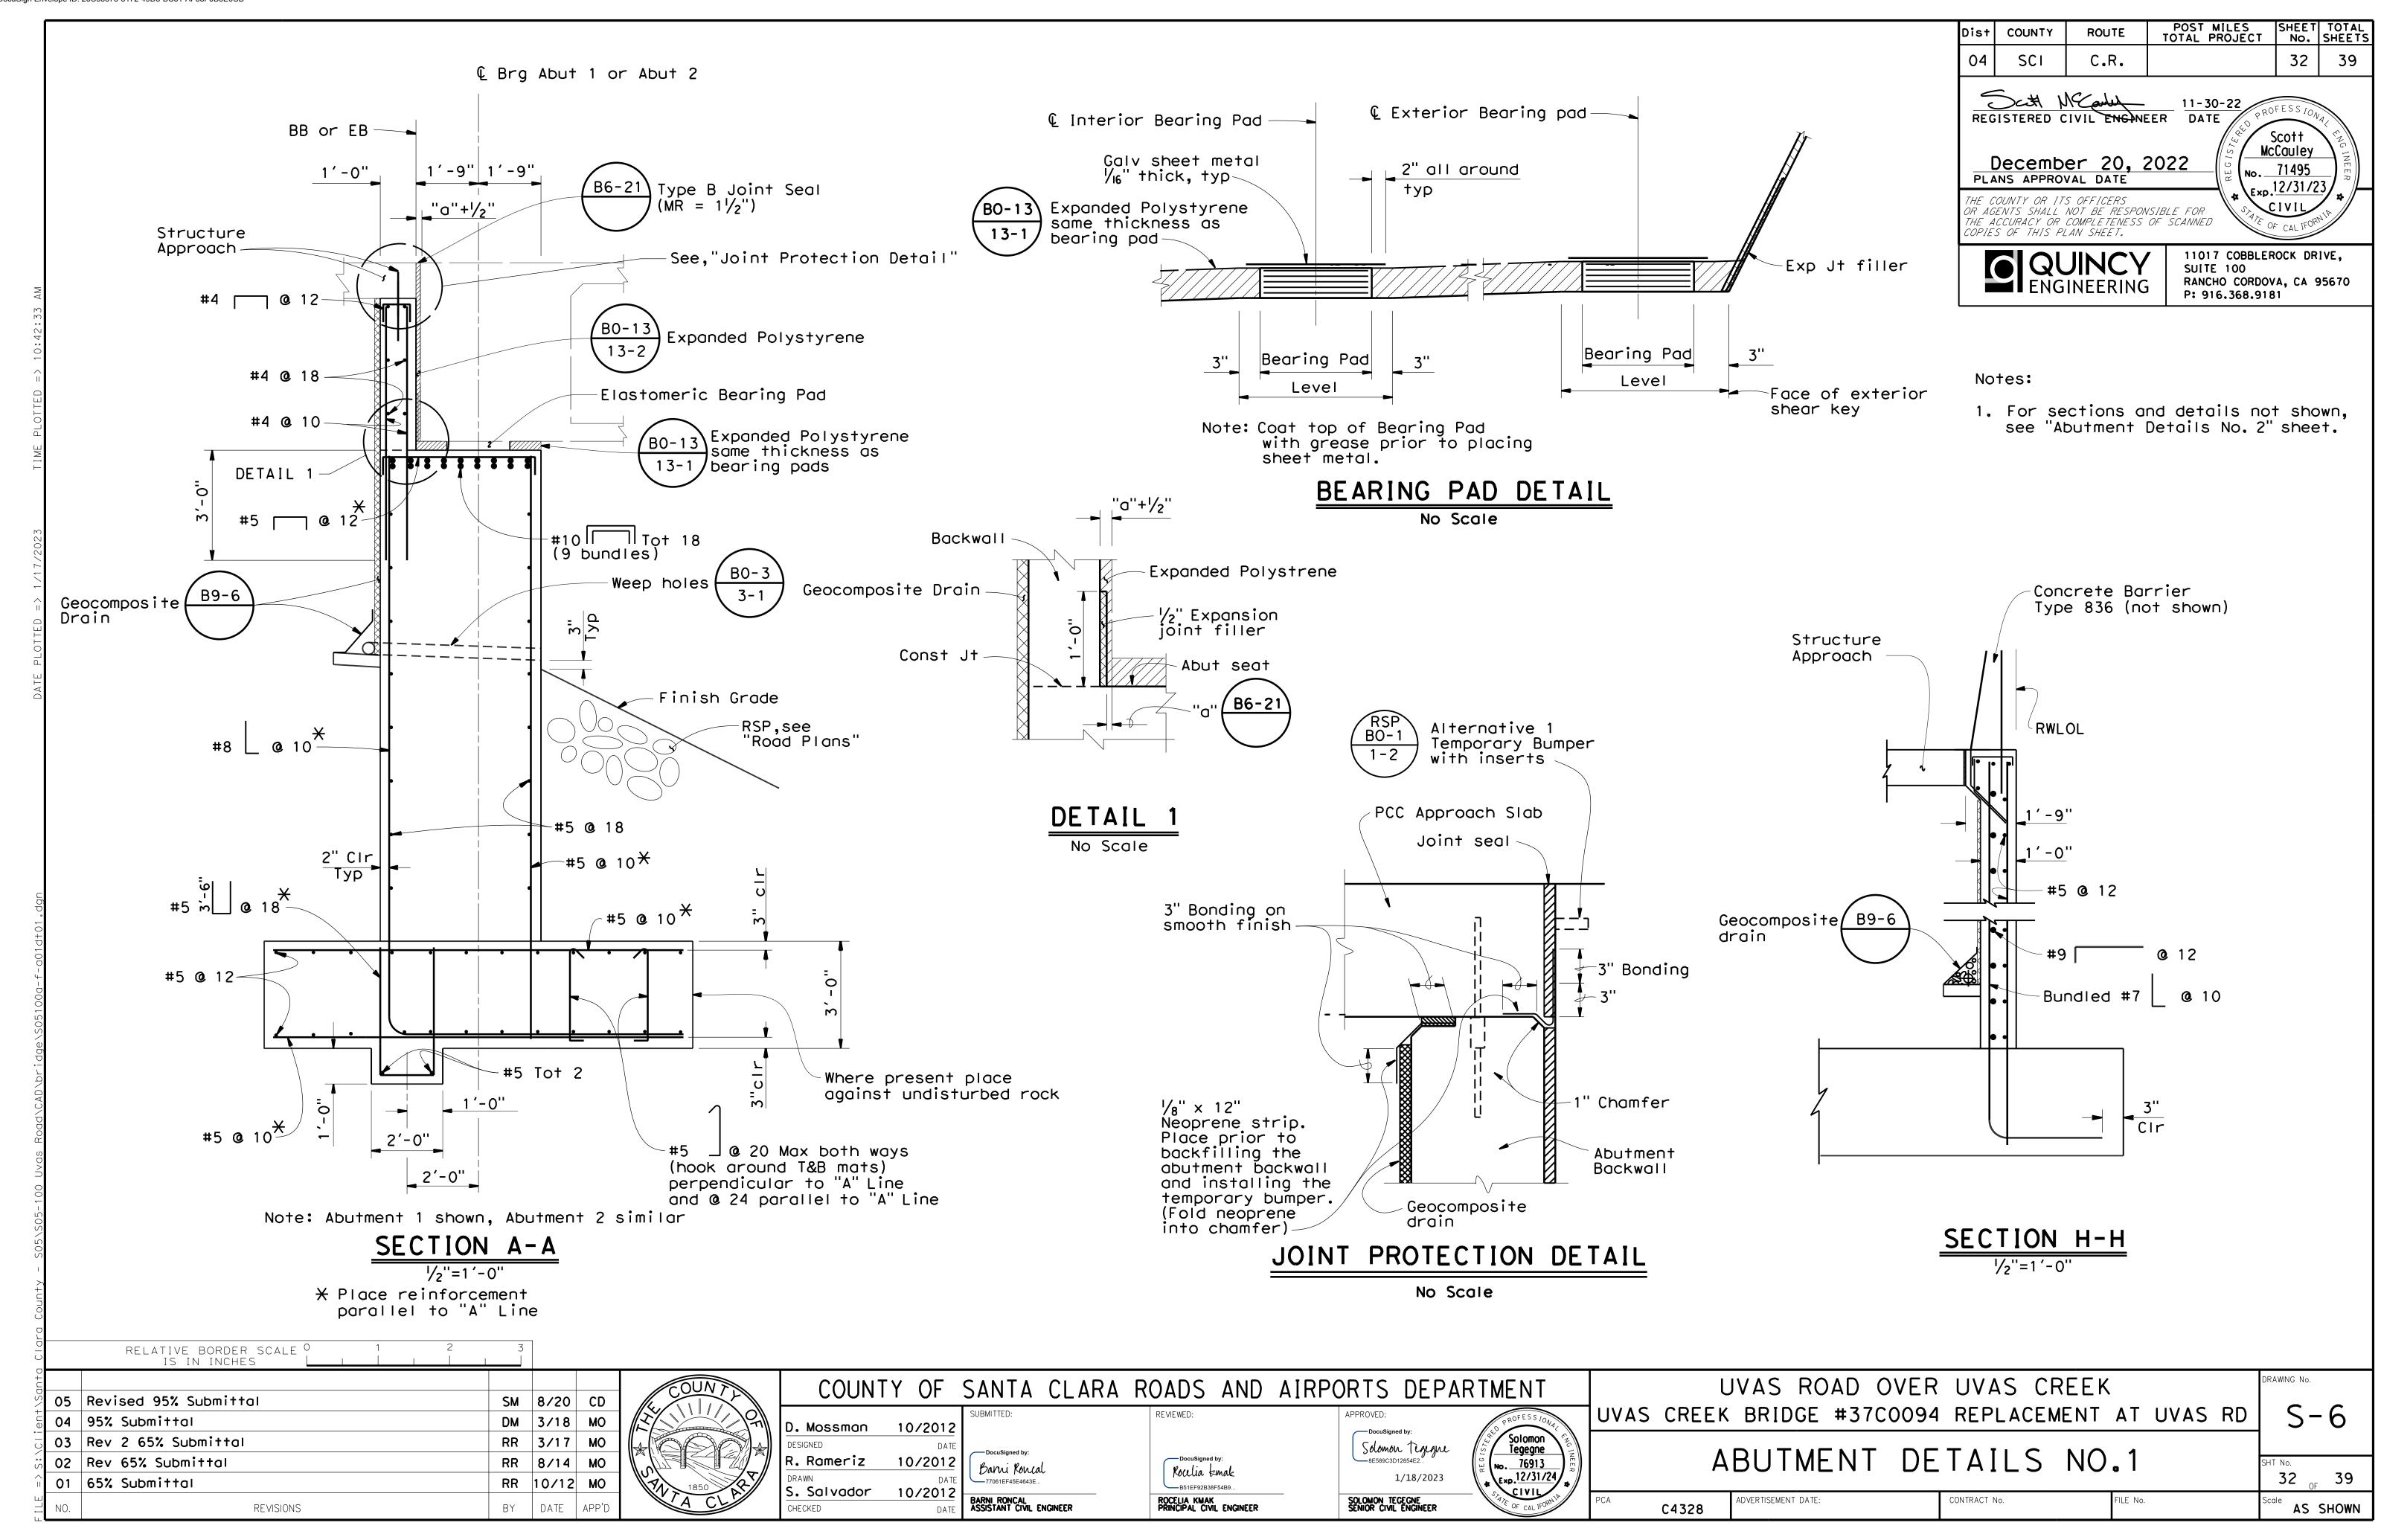


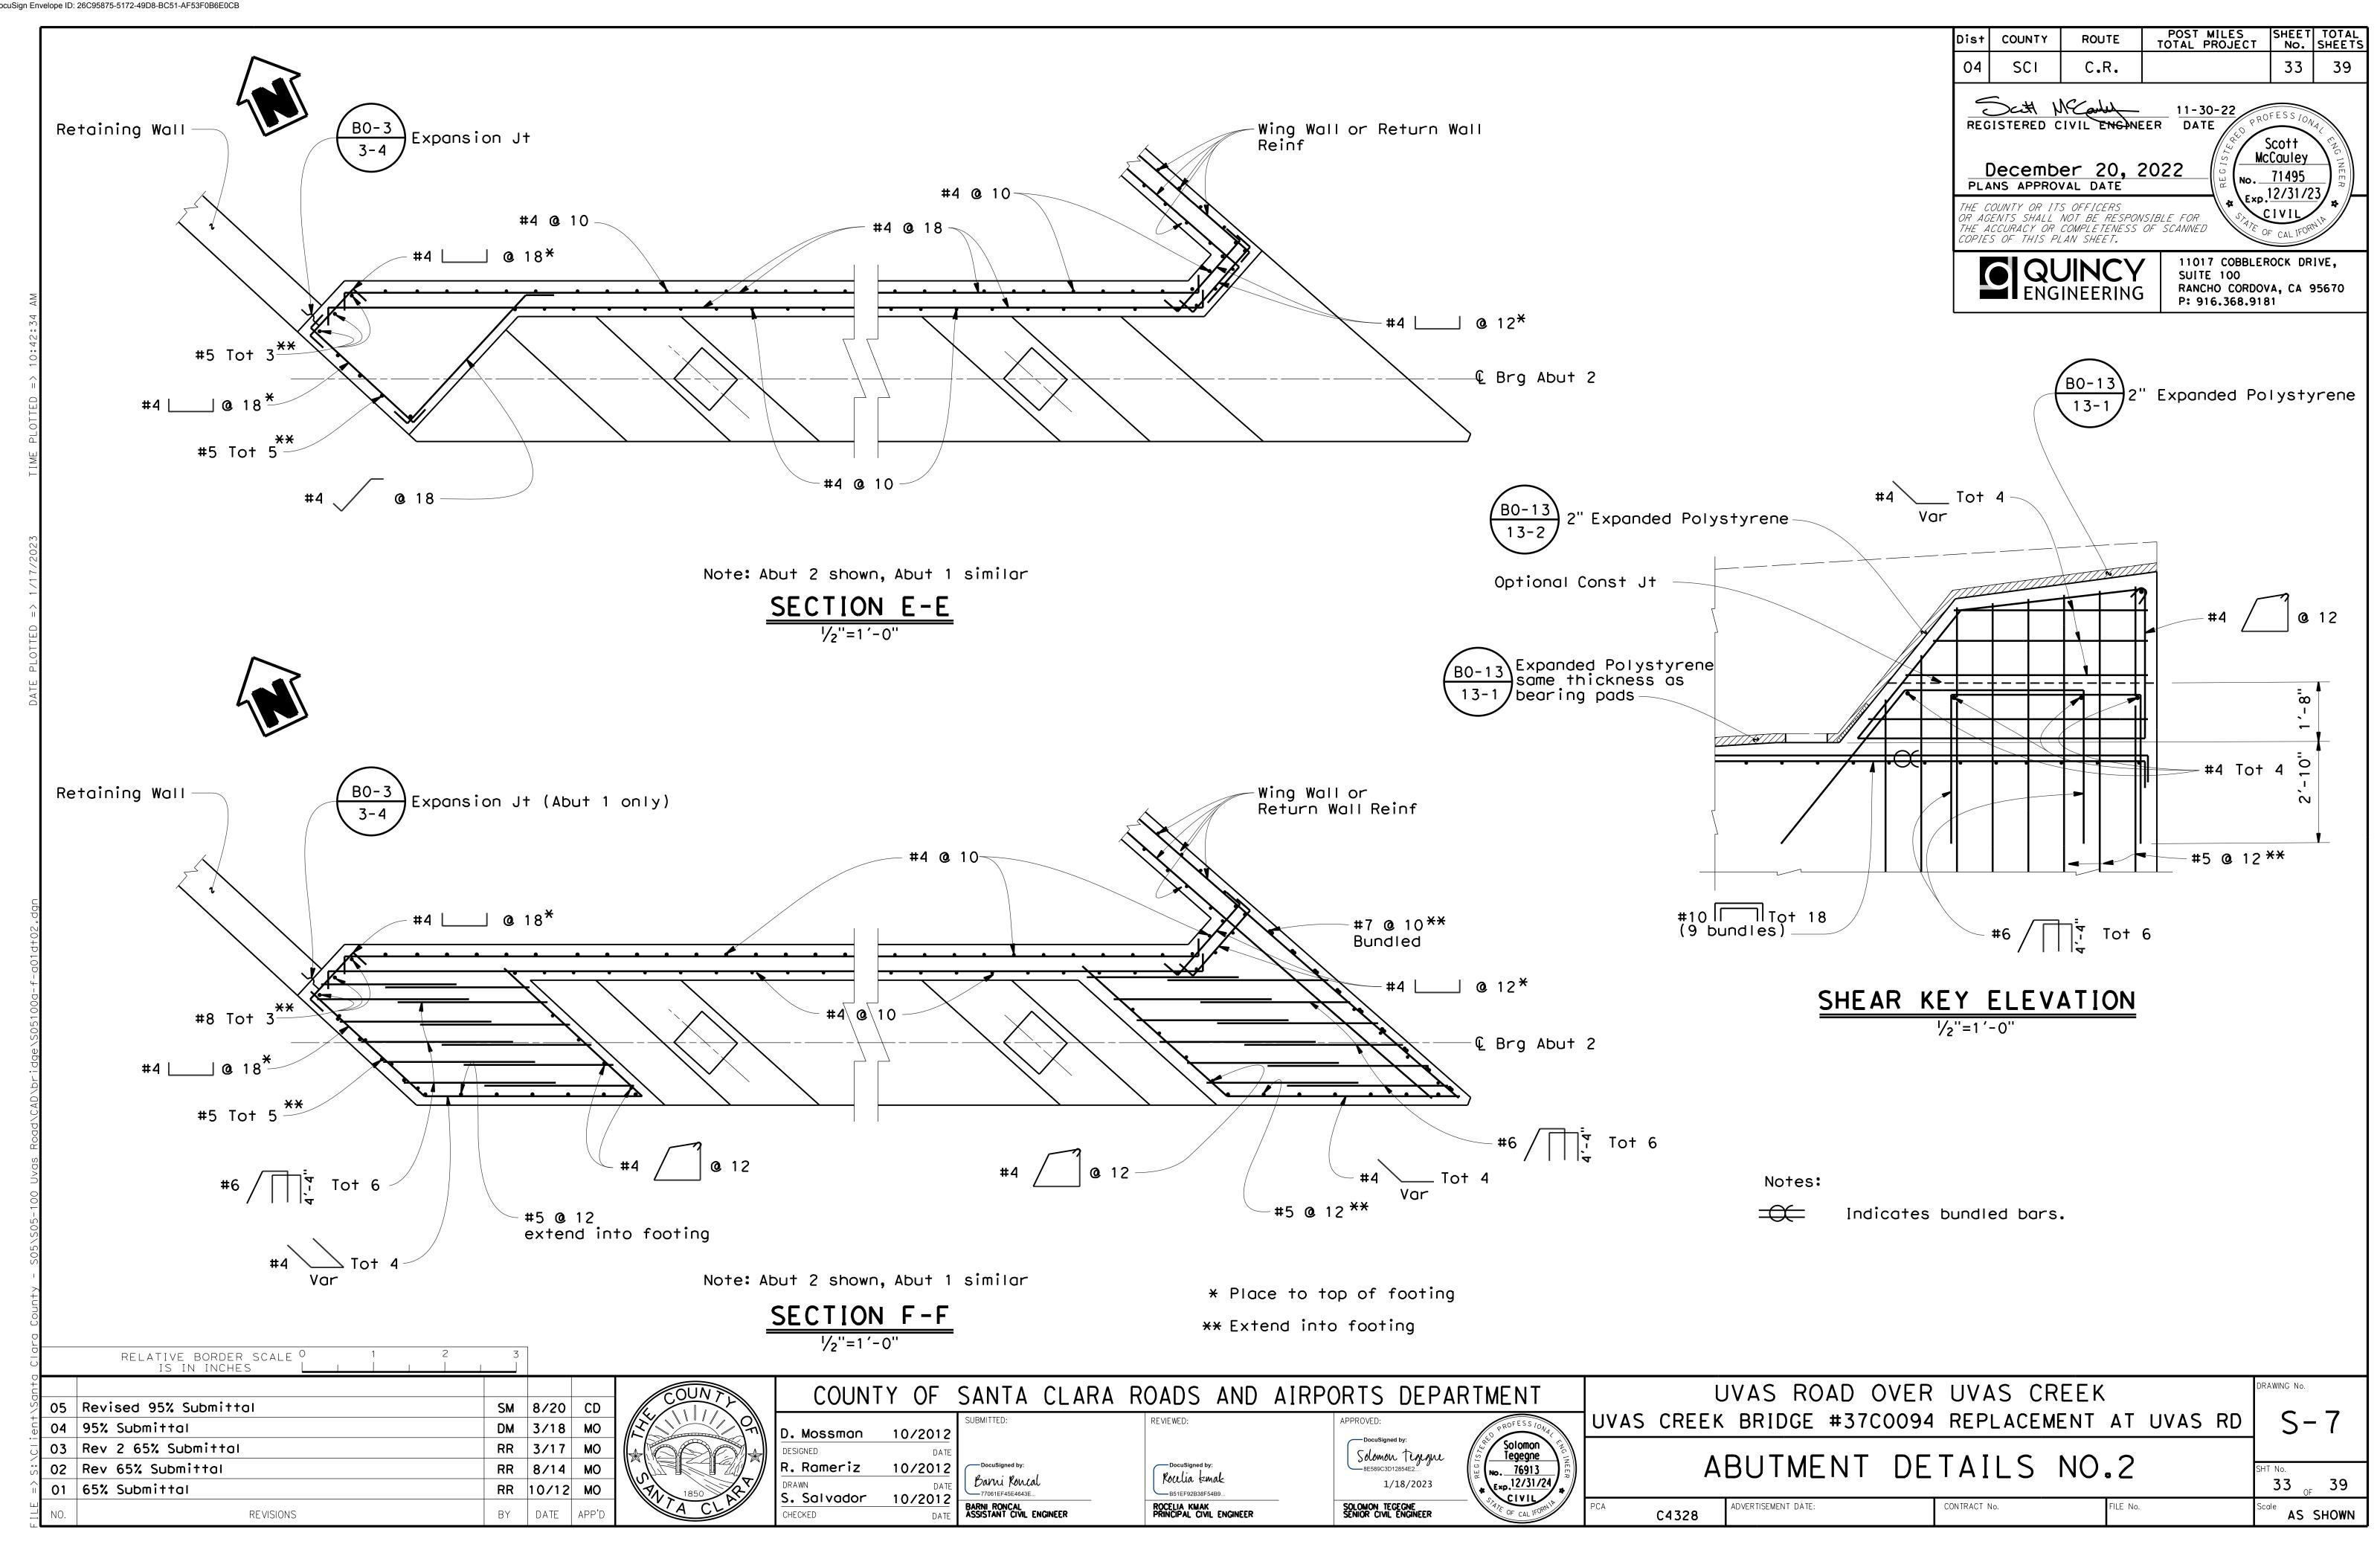

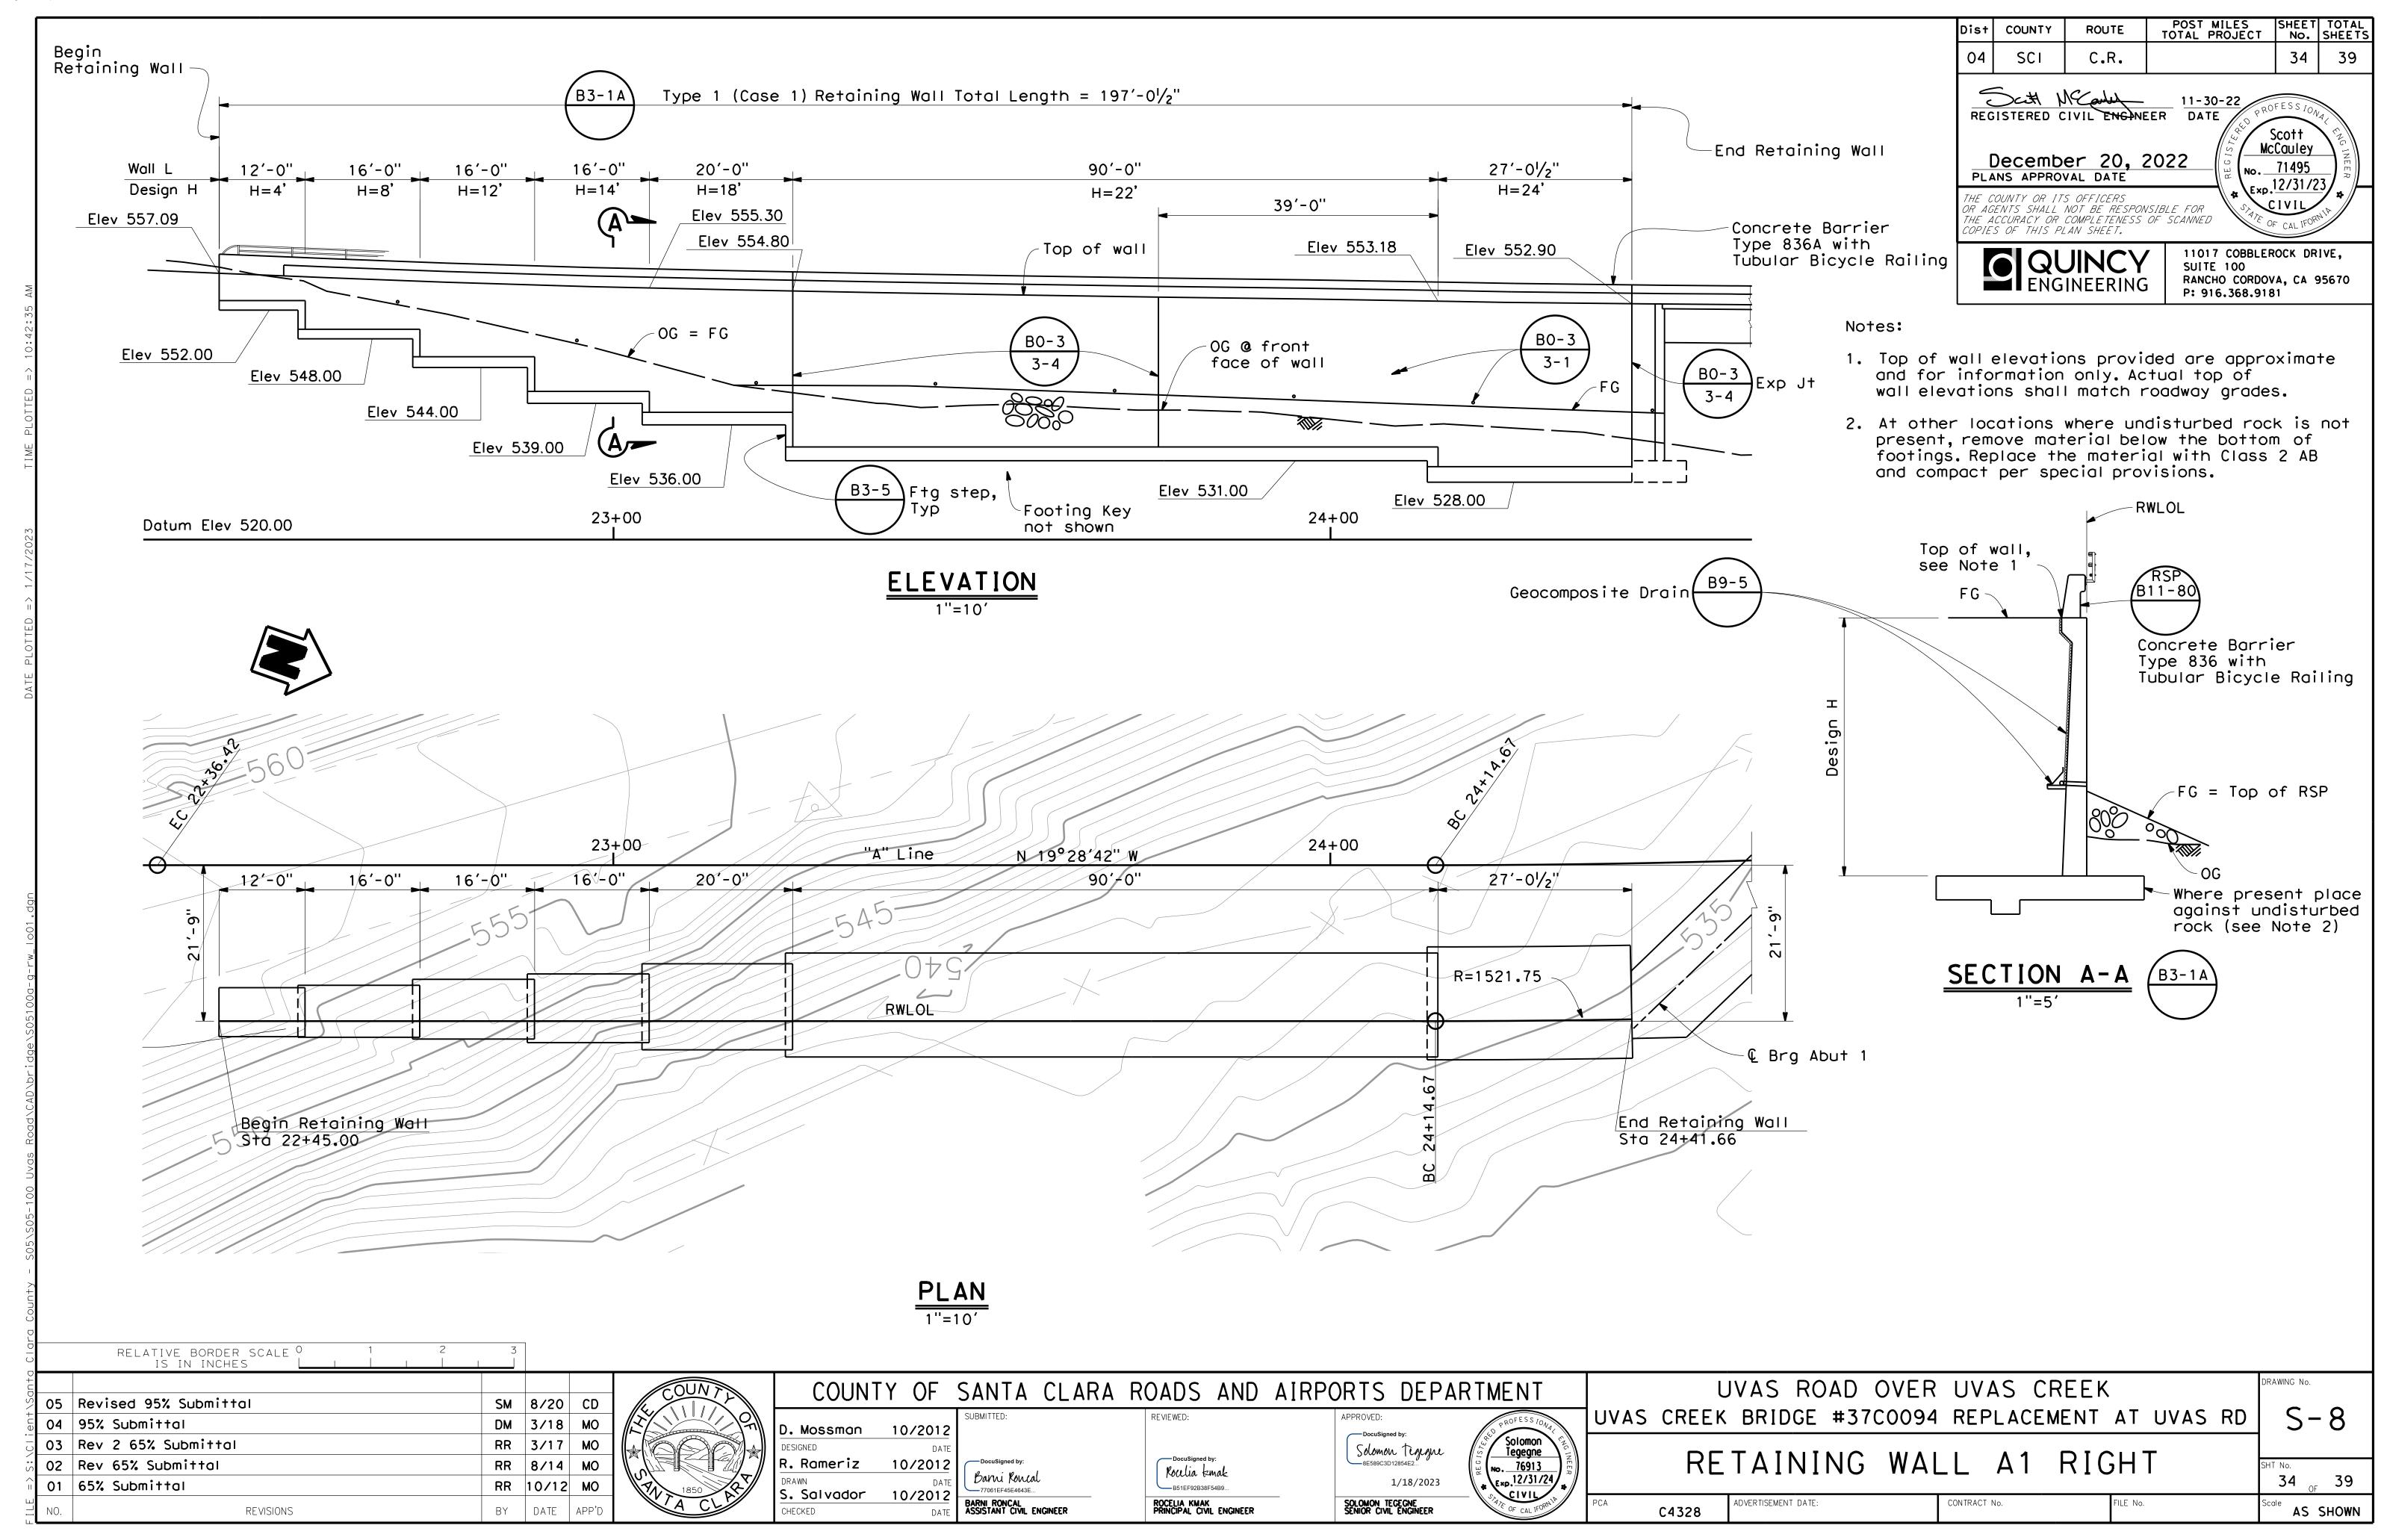

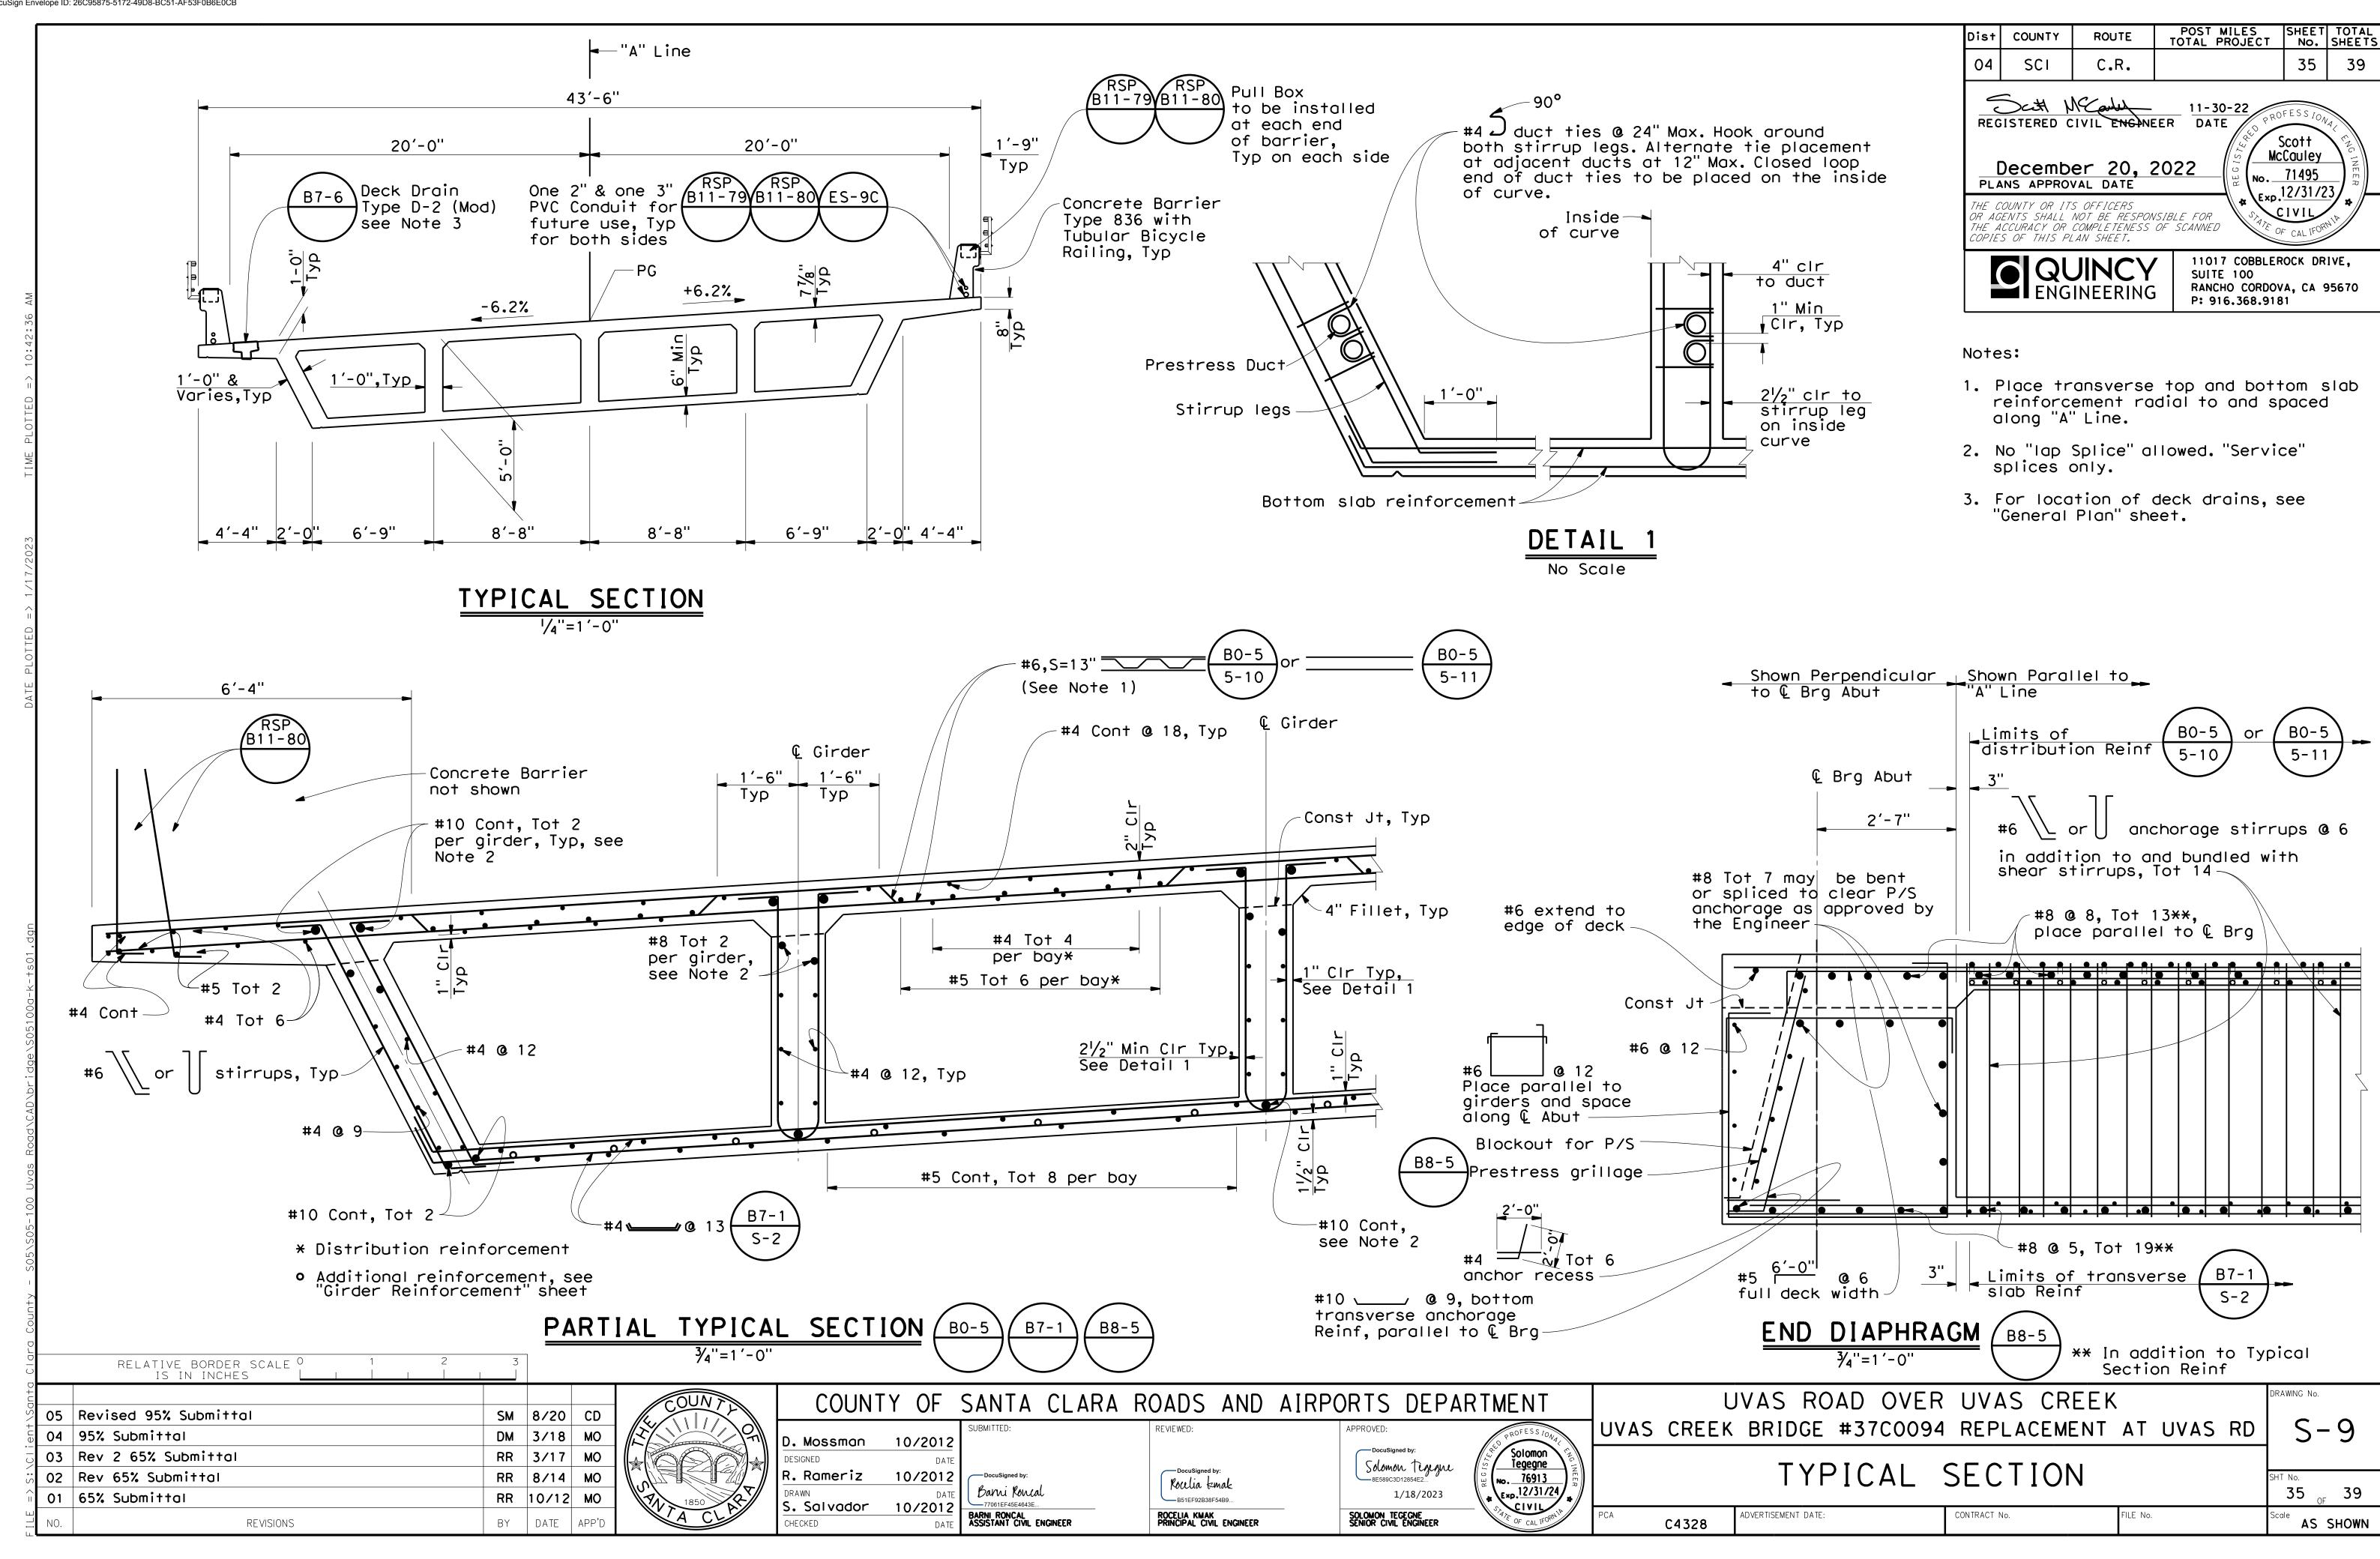

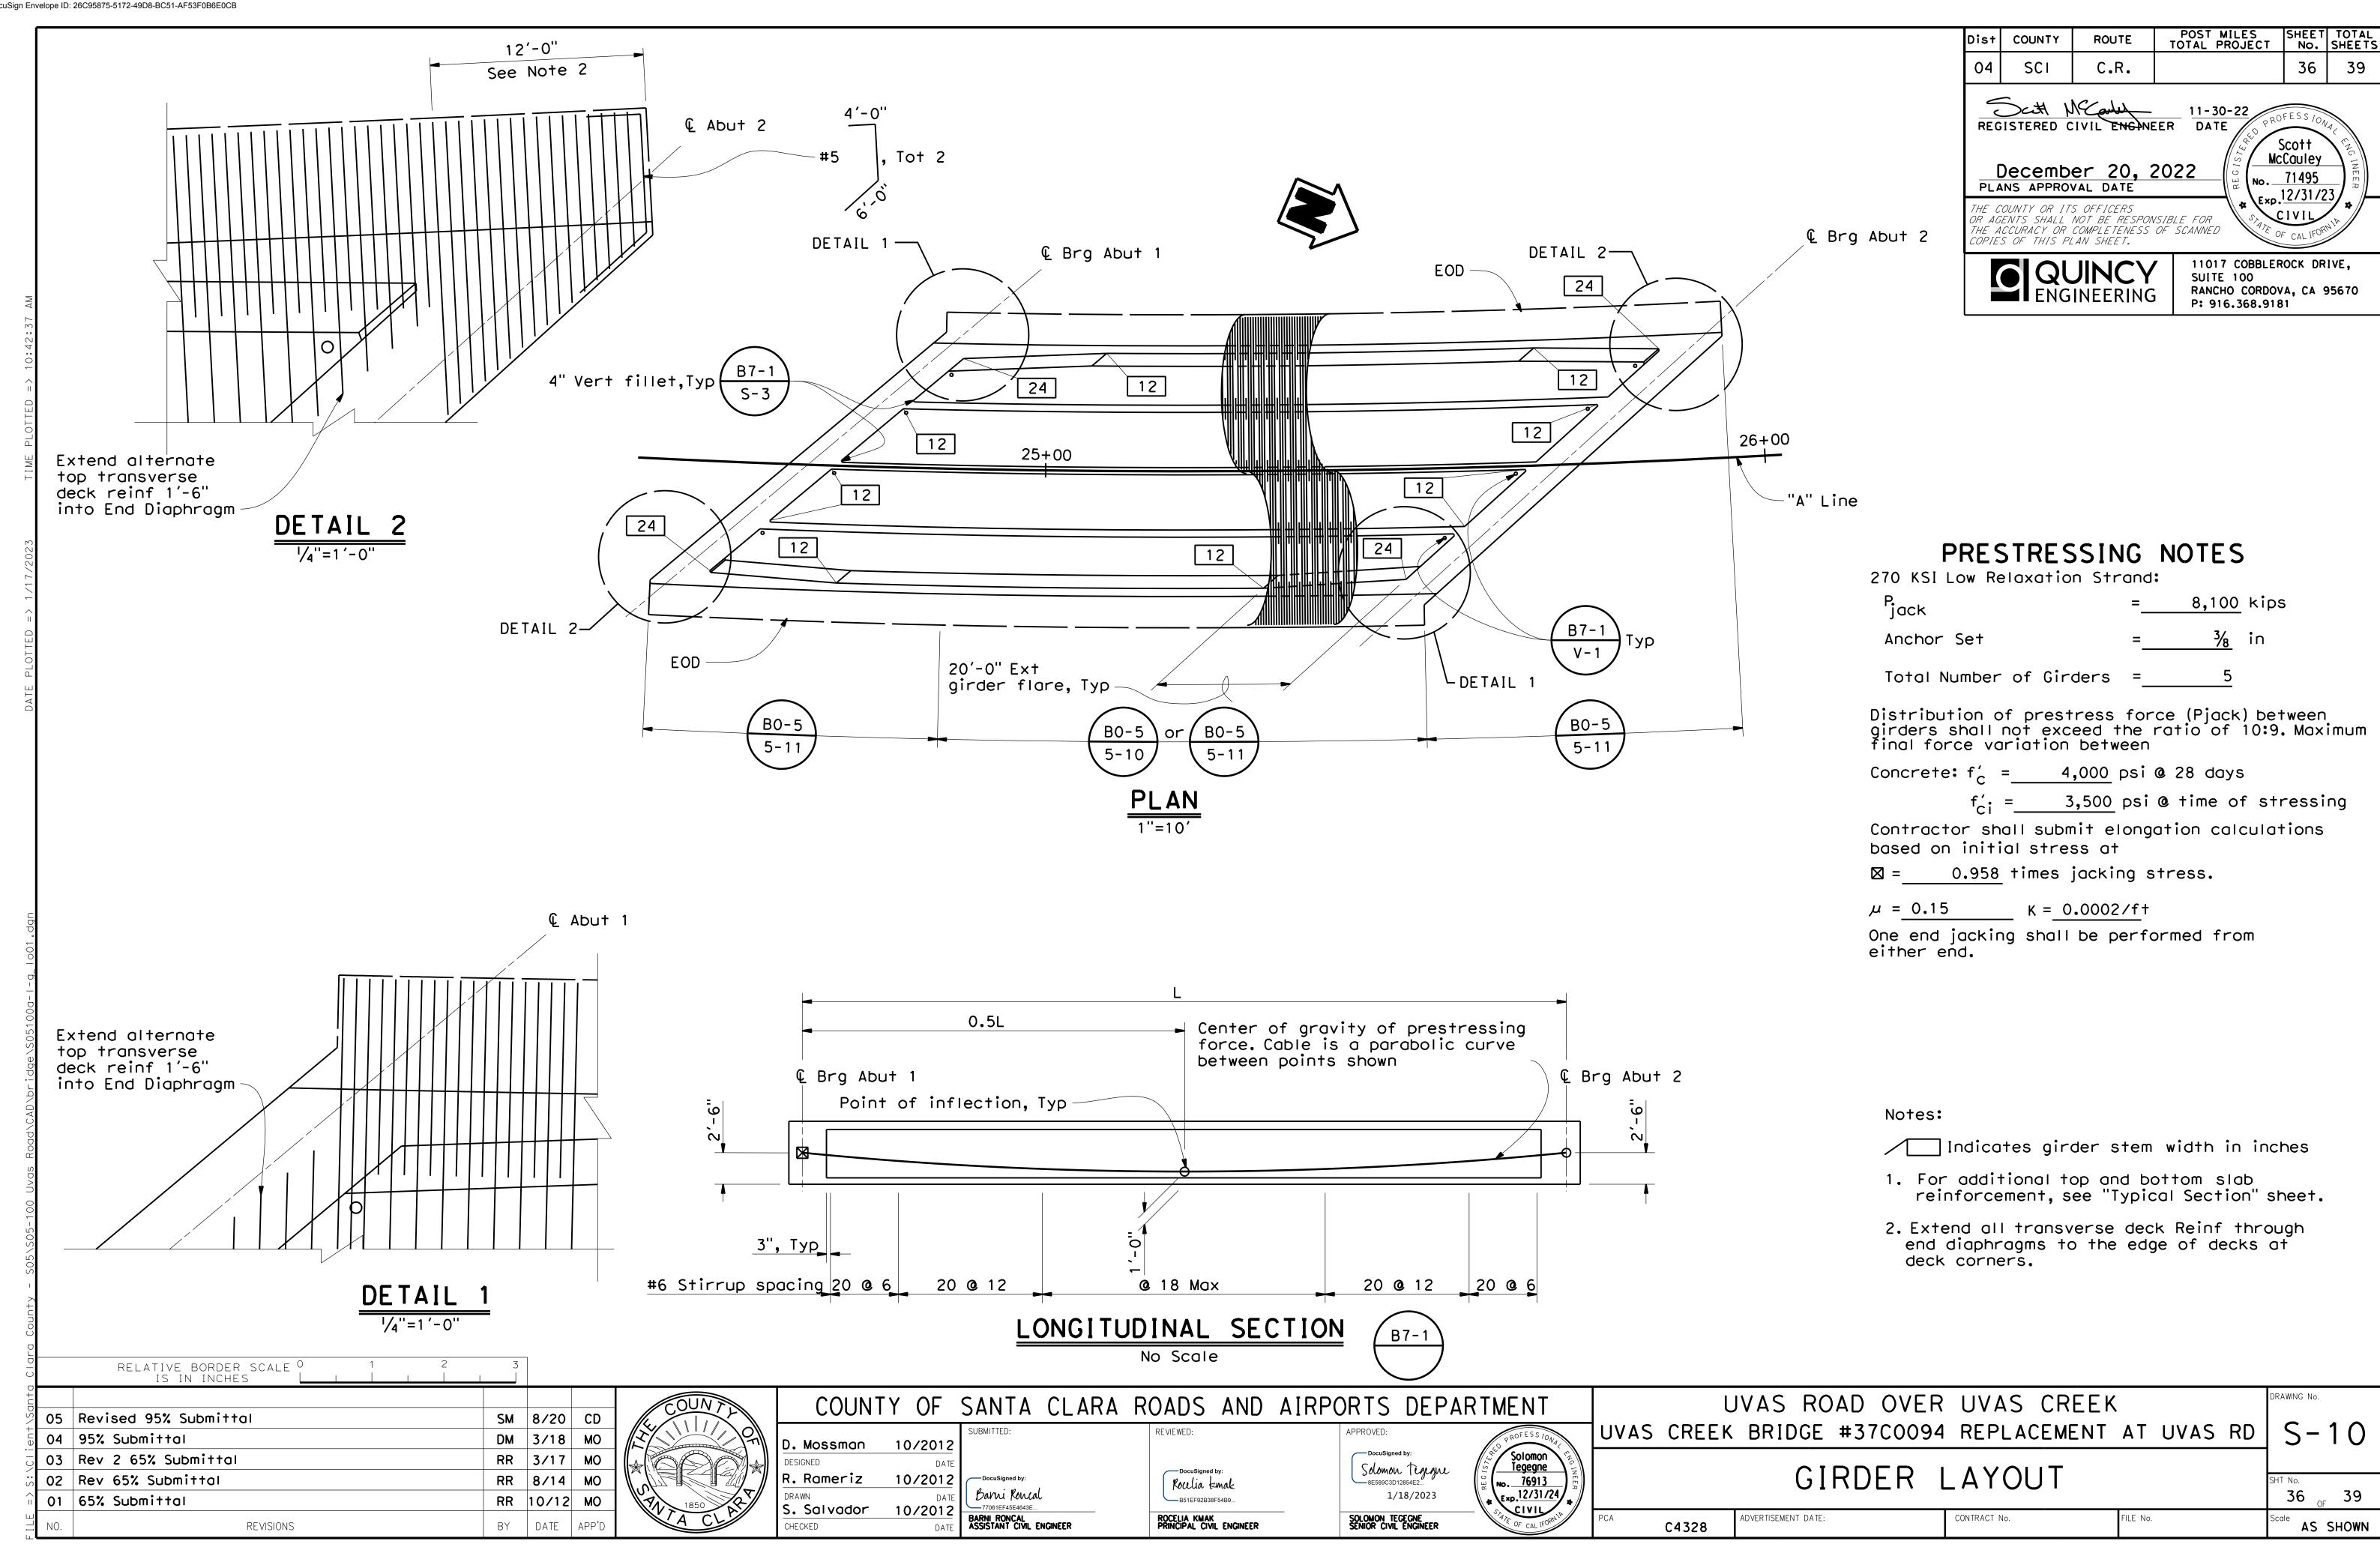

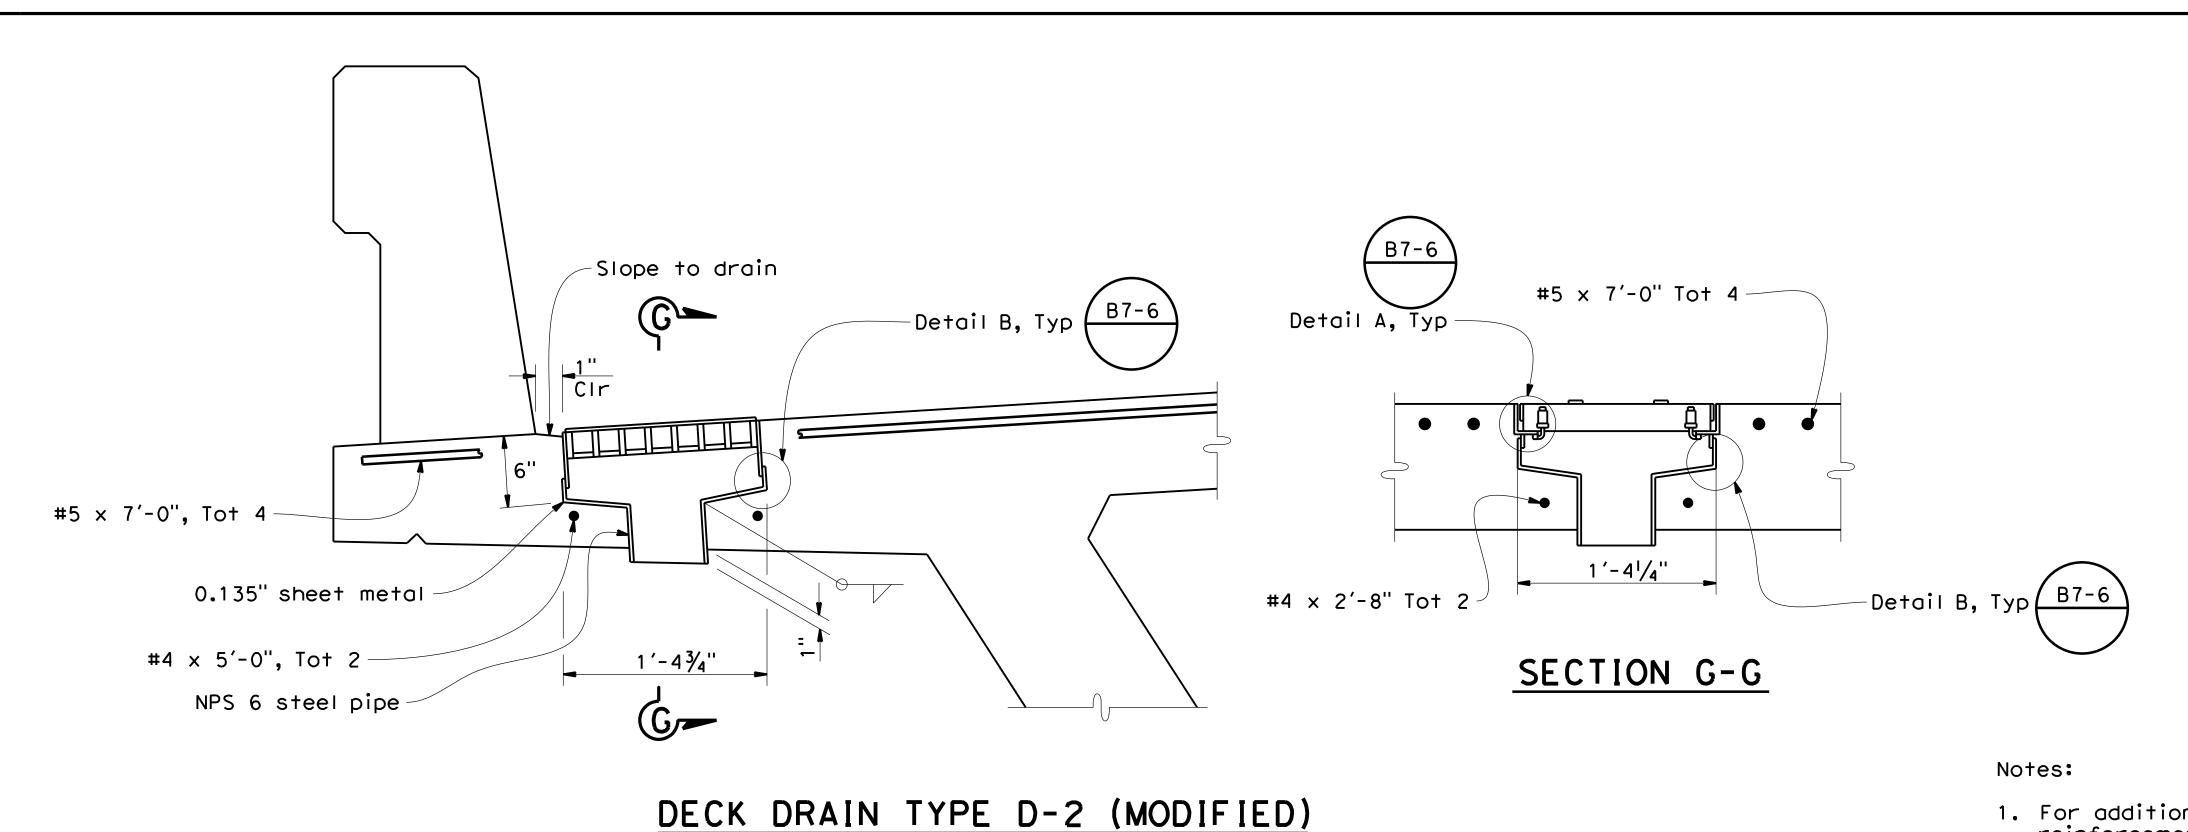

No Scale

For additional top and bottom slab reinforcement, see "Typical Section" sheet.

Dist

04

COUNTY

SCI

C.R.

REGISTERED CIVIL ENGINEER DATE

December 20, 2022
PLANS APPROVAL DATE

**QUINCY** ENGINEERING

THE COUNTY OR ITS OFFICERS OR AGENTS SHALL NOT BE RESPONSIBLE FOR THE ACCURACY OR COMPLETENESS OF SCANNED COPIES OF THIS PLAN SHEET.

2. For details not shown see /B7-6

3. For location of deck drains see "General Plan" sheet.

POST MILES SHEET TOTAL TOTAL PROJECT No. SHEETS


37

McCauley

Exp. 12/31/23

No. 71495

11017 COBBLEROCK DRIVE, SUITE 100 RANCHO CORDOVA, CA 95670 P: 916.368.9181

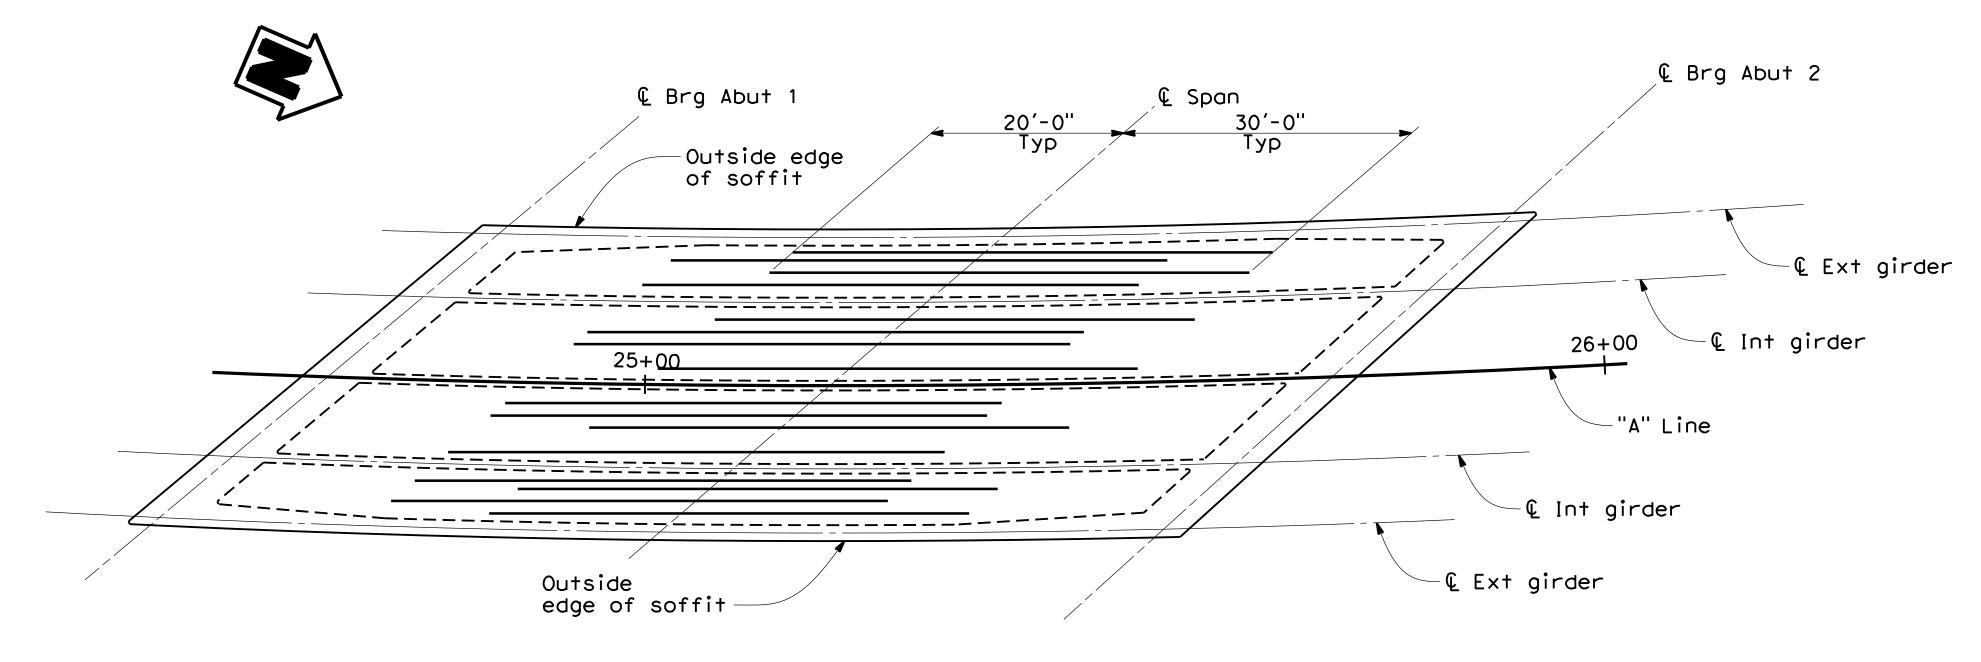

Note: All Reinf #11  $\times$  50'-0" Total 4 per bay, no splices allowed.

BOTTOM SLAB REINFORCEMENT RELATIVE BORDER SCALE O
IS IN INCHES UVAS ROAD OVER UVAS CREEK COUNTY OF SANTA CLARA ROADS AND AIRPORTS DEPARTMENT 05 Revised 95% Submittal SM 8/20 CD S-11 UVAS CREEK BRIDGE #37C0094 REPLACEMENT AT UVAS RD DM 3/18 MO 04 95% Submittal 10/2012 D. Mossman Solomon Tegegne No. 76913 Exp. 12/31/24 03 Rev 2 65% Submittal RR 3/17 MO Solomon Tigigne
8E589C3D12854E2... GIRDER REINFORCEMENT 10/2012 R. Rameriz 02 Rev 65% Submittal RR 8/14 MO Rocelia Emak Barni Roncal 37 <sub>OF</sub> 39 1/18/2023 01 65% Submittal RR 10/12 MO S. Salvador 10/2012 BARNI RONCAL ASSISTANT CIVIL ENGINEER SOLOMON TEGEGNE SENIOR CIVIL ENGINEER ADVERTISEMENT DATE: CONTRACT No. ROCELIA KMAK PRINCIPAL CIVIL ENGINEER AS SHOWN BY DATE REVISIONS C4328

